2023 VTrans Bicycle and Pedestrian Grant Application - **Request for Additional Funds**

1.	1. Project Title:		
2.	2. Existing Project Name/Number		
3.	3. Applicant Name(s):		
4.	4. Project Contact Info:		
	a. Name:		
	b. Mailing Address:		
	c. Town:		
	d. Zip Code:		
	e. Email Address:		
	f. Phone Number:		
5.	5. Fiscal Information:		
	a. Accounting System Automated	Manual	Combination
	b. Unique Entity Identifier #		
	c. Fiscal Year End Month		
6.	6. RPC(s)		
7.	7. Project Description:		
in	Please give a brief description of the project (10 information should be submitted as part of address to include identifying streets or landmarks that the	essing the selec	tion criteria. Be sure

8. TOTAL ADDITIONAL FUNDING AMOUNT APPLIED FOR: (taken from the attached "Additional Funding

Worksheet", including 20% local share)

2023 VTrans Bicycle/Pedestrian Program – Additional Funding Criteria Template

Applicant Name: Town of Windsor

Existing Project Name and Number: River Street Sidewalk Improvement Project [TCSP TCSE(008)]

Brief Project Description: The Phase III of the project will make streetscape improvements to enhance the walkability and pedestrian safety along River Street, from the intersection of Main Street and River Street to the intersection of River and Jarvis Streets. The purpose of the project is to make sidewalk improvements, allowing for a wider sidewalk surface and improved safety for residents in a low-income neighborhood to walk to downtown Windsor.

Application Checklist

Make sure everything is included and pages numbered.

All other materials noted below to be provided in the same order as below.

- (2) Project Evaluation Criteria Documentation for the project (completed BELOW)
- (3) Copy of Right of Way clearance from VTrans and estimated schedule to complete contract plans and bid documents with estimated bid advertising date
- \boxtimes (4) Project Map(s)
- ⋈ (6) Additional Funds Calculator output (use VTrans provided Excel file).
- (8) Current letter of support from the municipal governing body acknowledging their willingness to provide the local match and future maintenance responsibility
- (9) Supporting Documentation (documentation of need for additional funds)

REQUESTS FOR ADDITIONAL FUNDING

1. <u>Project Funding Need – 20 Points:</u> Describe the situation that led to the need to apply for additional funds.

This is a legacy project that was initially funded through an earmark from Senator Jeffords. Additional funds are needed due to project delays and inflationary cost increases. This project has gone through numerous changes in town personnel, including a number of Town Managers and community development staff. Most recently, the community development person in charge of aspects of the project, including the temporary easements, resigned. Now the MPM from the RPC is working on that with town staff. The project scope needed to be adjusted a few years ago, due to the costs and difficulty dealing with the railroad. The project has also had difficulty getting landowners to sign the easement documentation. Lastly, inflation in material and personnel costs have increased substantially over the last several years.

11-20 Points – Presents valid unforeseeable causes of budget increases – e.g. permitting requirements, changes to scope The largest driver of the project cost increases has been the increase in materials and personnel. The rate of inflation over the last several years was unforeseen when developing the original budget.

0-10 Points – The Town of Windsor is a small town with very limited staff to work on this project. To try and save money, they tried to use their own staff and not contract for the services. The town has changed course and has hired the Mount Ascutney Regional Commission to assist with getting the easements signed.

2. <u>Funding Documentation – 10 Points:</u> Provide any explanatory text regarding documentation of the project budget shortfall.

The original Phase III funding of \$193,630 from 2016 (CA0174, Amendment #5) is not sufficient to complete the project scope at this time. On April 12, 2023, we received an updated project cost estimate from Marble Valley Engineering. The significant increase in construction costs was from \$123,356.00 to \$225,000.00; an increase of \$101,644.00. There are corresponding cost increases for design, project management, and construction inspection. (See additional information in the attachments.)

6-10 Points – Presents clear historical and future funding outline utilizing the provided worksheet.

(See attachment)

0-5 Points – Presents historical and future funding outline in alternate format, or information presented is incomplete or unclear.

Copy of Right of Way Clearance

Copy of Right of Way clearance from VTrans and estimated schedule to complete contract plans and bid documents with estimated bid advertising date

At the present time, this project is still in the Right-of-Way phase. We have four temporary easements that still need to be signed. We are currently working on that, and plan to knock on doors this summer accompanied by Windsor police. No clearance has been issued yet.

We anticipate going to construction during the summer of 2024, if we can successfully obtain ROW clearance. If condemnation is required for an unresponsive property owner(s), it may not go to construction for another year.






River St Sidewalk Improvement Location Map

Vermont Agency of Natural Resources

vermont.gov

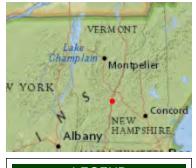

1: 9,739

LEGEND

Parcels (standardized)

Roads

Interstate

US Highway; 1

State Highway

Town Highway (Class 1)

Town Highway (Class 2,3)

Town Highway (Class 4)

State Forest Trail

National Forest Trail

Legal Trail

Private Road/Driveway

Proposed Roads

Town Boundary

NOTES

Map created using ANR's Natural Resources Atlas

495.0 0 248.00 495.0 Meters


WGS_1984_Web_Mercator_Auxiliary_Sphere 1" = 812 Ft. 1cm = 97 Meters

© Vermont Agency of Natural Resources THIS MAP IS NOT TO BE USED FOR NAVIGATION

DISCLAIMER: This map is for general reference only. Data layers that appear on this map may or may not be accurate, current, or otherwise reliable. ANR and the State of Vermont make no representations of any kind, including but not limited to, the warranties of merchantability, or fitness for a particular use, nor are any such warranties to be implied with respect to the data on this map.

PLANS FOR CONSTRUCTION OF WINDSOR TCSP TSCE (008) C/3 WINDSOR STREETSCAPES WINDSOR, VERMONT

FEBRUARY, 2020

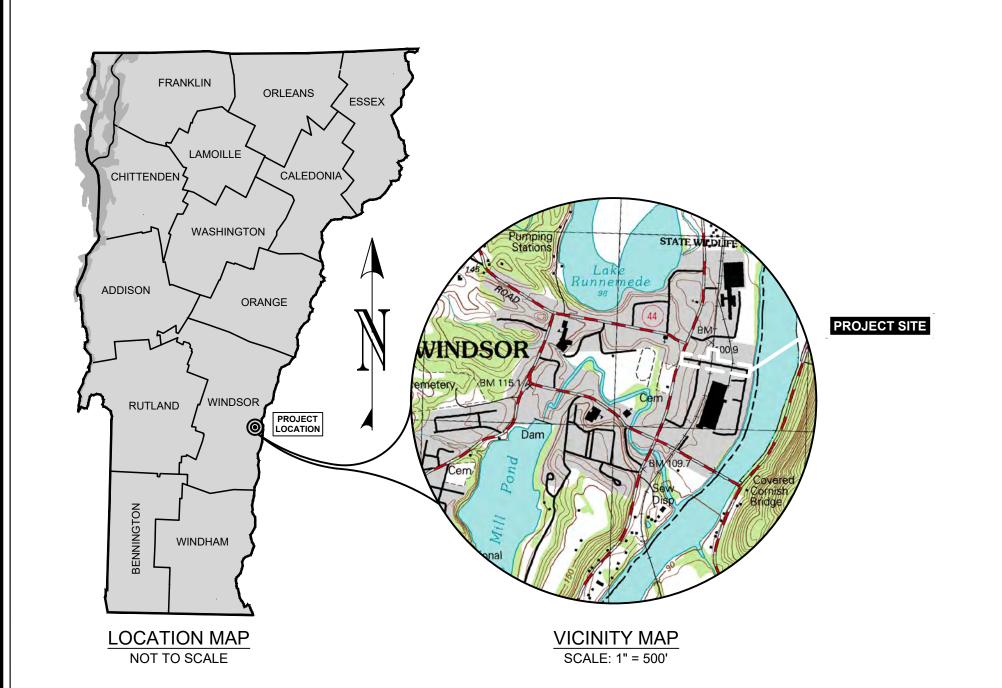

	SHEET SCHEDULE
G001	COVER
G002	ABBREVIATIONS & NOTES
G003	QUANTITIES
C001	TYPICAL DETAILS
C002	LAYOUT PLAN & PROFILE - RIVER STREET WEST
C003	LAYOUT PLAN & PROFILE - RIVER STREET EAST
C004	CROSS SECTIONS (1 of 2)
C005	CROSS SECTIONS (2 of 2)
C006	TRAFFIC CONTROL PLAN
C007	ROW PLAN - WEST
C008	ROW PLAN - EAST
C009	ROW DETAIL SHEET
C010	ROW TIE SHEET
C011	EPSC MEASURES & DETAILS

PROJECT LOCATION:

BEGINNING AT MAIN STREET AND EXTENDING APPROXIMATELY 310 LINEAR FEET ALONG THE SOUTH SIDE OF RIVER STREET TO CENTRAL STREET; BEGINNING AT ACME STREET AND EXTENDING APPROXIMATELY 460 LINEAR FEET TO THE WEST ALONG THE NORTH SIDE OF RIVER STREET.

LENGTH OF PROJECT: ±770 LF LENGTH OF SIDEWALK: ±530 LF

PROJECT DESCRIPTION:

WORK TO BE PERFORMED UNDER THIS PROJECT INCLUDES THE CONSTRUCTION OF CONCRETE SIDEWALK, GRANITE CURB AND INCIDENTAL ITEMS.

CLASSIFICATION:

URBAN LOCAL STREET

VTRANS QUALITY ASSURANCE PROGRAM:

LEVEL

SPECIFICATIONS:


ALL WORK SHALL BE PERFORMED IN ACCORDANCE WITH THE VTRANS 2018 STANDARD SPECIFICATIONS FOR CONSTRUCTION

SURVEY CONTROL:


BASED ON NAD 83 & USES DISC-PID #OD0098

VTRANS STANDARD SHEETS

SHEET#	TITLE	DATE
C-2A	PORTLAND CEMENT CONCRETE SIDEWALK DRIVE ENTRANCES WITH SIDEWALK ADJACENT TO CURB	10-14-05
C-2B	PORTLAND CEMENT CONCRETE SIDEWALK DRIVE ENTRANCES WITH GREEN STRIP	10-14-05
C-3A	SIDEWALK RAMPS	3-10-08
C-3B	SIDEWALK RAMPS AND MEDIAN ISLANDS	3-10-08
C-10	CURBING	2-11-08
E-121	STANDARD SIGN PLACEMENT CONVENTIONAL ROAD	8-8-95

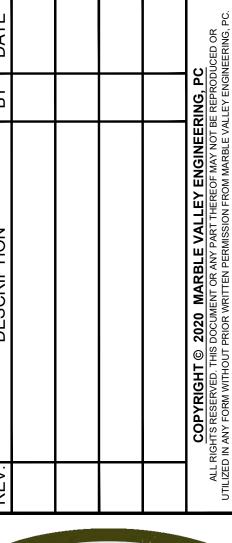



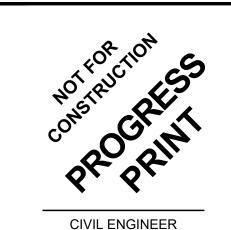

S FOR CONSTRUCTION OF OR TCSP TSCE (008) C/3 SOR STREETSCAPES WINDSOR, VERMONT


PROJECT NO.: M1104

DRAWN BY: PGF/SMC/RML

SCALE: AS NOTED

SHEET: G001

DATE: FEBRUARY 20, 2020

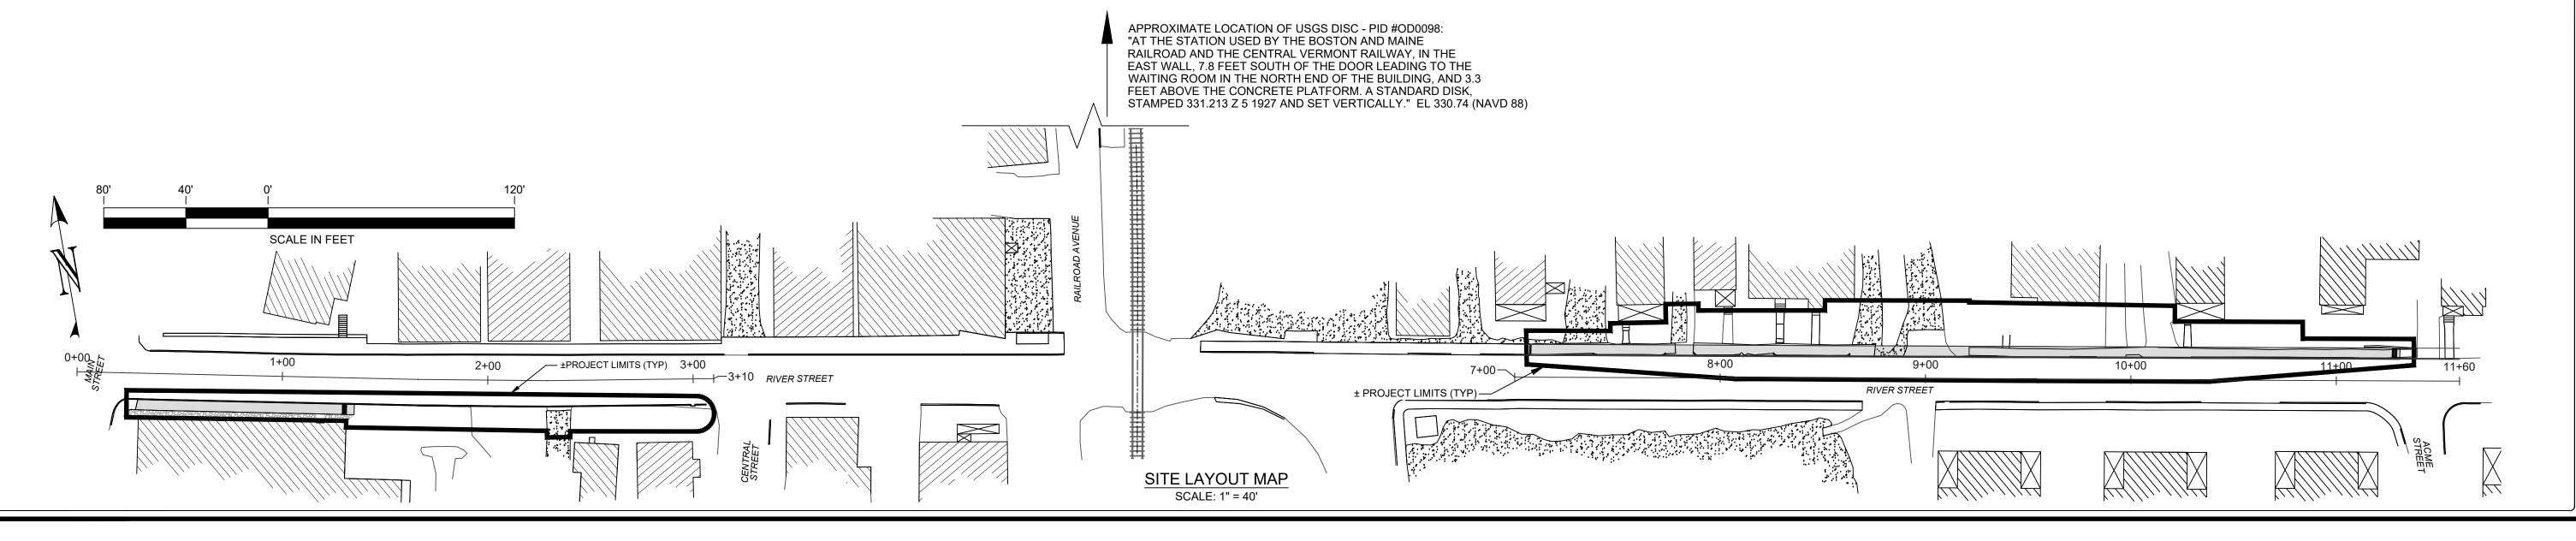

GENERAL NOTES:

- 1. THESE PLANS ARE TO BE USED WITH THE VTRANS 2018 STANDARD SPECIFICATIONS FOR CONSTRUCTION
- 2. THE CONTRACTOR IS REQUIRED TO LOCATE AND MARK ALL EXISTING UTILITIES WITHIN, AND IF NECESSARY, BEYOND THE PROJECT LIMITS INCLUDING EXISTING WATER MAINS, SANITARY SEWERS, STORM SEWERS, CULVERTS, CURB STOPS, PROPERTY MARKERS, ETC. ALL EXISTING UTILITIES SHOWN ON THESE PLANS ARE APPROXIMATE ONLY. CONTRACTOR TO FIELD LOCATE & FLAG EXISTING UTILITIES USING A PIPE LOCATOR OR AS REQUIRED, PRIOR TO CONSTRUCTION. IF CONTRACTOR DOES NOT HAVE NECESSARY EQUIPMENT, OR AN EXPERIENCED OPERATOR, THEN CONTRACTOR SHALL HIRE SUCH SERVICES, TO BE INCLUDED IN THE BID. CONSTRUCTION SHALL NOT PROCEED IN ANY AREA WHERE EXISTING MAINS/ SERVICES/ UTILITIES HAVE NOT BEEN LOCATED TO THE CONTRACTOR'S BEST ABILITY TO DO SO. CONTRACTOR SHALL COORDINATE WITH DIG SAFE (1-888-DIG-SAFE) A MINIMUM OF 72 HOURS PRIOR TO EXCAVATION.
- 3. AT LEAST SEVEN (7) DAYS PRIOR TO BEGINNING CONSTRUCTION, CONTRACTOR SHALL NOTIFY THE ENGINEER AND THE TOWN OF WINDSOR TO ALLOW TIME FOR PREPARATION OF ANY NECESSARY MEASURES.
- 4. CONTRACTOR SHALL NOT DISRUPT UTILITY SERVICES OR TRAFFIC FLOW WITHOUT A 48-HOUR NOTICE TO ALL AFFECTED PARTIES INCLUDING BUT NOT LIMITED TO: NEW ENGLAND CENTRAL RAILROAD, GENESEE & WYOMING, INC., THE TOWN FIRE DEPARTMENT AND THE TOWN MANAGER.
- 4.1. CONTRACTOR SHALL EXERCISE DUE CARE TO PREVENT DAMAGE TO ROOT SYSTEMS OF EXISTING VEGETATION. ALL GRASS AREAS DISTURBED SHALL BE RESTORED TO CLASS A RESTORATION. CONTRACTOR IS RESPONSIBLE FOR REMOVAL, CARE, & REPLANTING OF ALL PLANTINGS AND SHRUBS DISTURBED DURING CONSTRUCTION
- 4.2. CONTRACTOR SHALL CONTACT THE LOCAL POWER UTILITY & THE LOCAL TELEPHONE UTILITY REGARDING ANY NECESSARY SUPPORT OF ANY UTILITY POLES DURING CONSTRUCTION. THE LOCAL ELECTRIC UTILITY IS GREEN MOUNTAIN POWER (802-751-3210). THE LOCAL TELEPHONE UTILITY IS CONSOLIDATED COMMUNICATIONS (802-584-9911 or 866-984-2001).
- 4.3. CONTRACTOR SHALL MAKE EVERY EFFORT TO ALLOW ACCESS TO AND FROM DRIVEWAYS LOCATED ALONG THE ROUTE OF CONSTRUCTION.
- 4.4. CONTRACTOR SHALL MAINTAIN ONE LANE OPEN TO TRAFFIC AT ALL TIMES AND SHALL MINIMIZE IMPACTS TO AUTOMOBILE AND PEDESTRIAN TRAFFIC. ALL CONSTRUCTION SHALL COMPLY WITH THE MANUAL OF UNIFORM TRAFFIC CONTROL DEVICES, LATEST EDITION.
- 4.5. ANY SPOT ELEVATIONS ARE PROVIDED FOR REFERENCE ONLY. FINAL ELEVATIONS MAY VARY AS NECESSARY TO MAINTAIN DRAINAGE AND COMPLIANCE OF ALL SIDEWALK IMPROVEMENTS WITH AMERICAN DISABILITIES ACT REQUIREMENTS, AND THE CONTRACT DOCUMENTS, LATEST VERSIONS. TRUNCATED DOMES ARE A REQUIREMENT FOR THIS PROJECT. REFER TO VAOT DETAIL DRAWINGS REFERENCED.
- 4.6. REFER TO ADDITIONAL DETAILS ON SHEET C001 FOR SIDEWALK, RAMP, CURB, CROSSWALK, DRIVES, AND OTHER APPURTENANT CONSTRUCTION REQUIREMENTS.
- 4.7. CONTRACTOR SHALL COMPLY WITH THE LOW RISK SITE HANDBOOK FOR EROSION PREVENTION AND SEDIMENT CONTROL.
- 5. CONTRACTOR SHALL MAINTAIN AND PROTECT SITE IN ACCORDANCE WITH ANY PERMIT(S) ISSUED.
- 6. THE CONTRACTOR SHALL BE RESPONSIBLE FOR ENSURING THAT ALL NECESSARY STATE AND LOCAL PERMITS HAVE BEEN OBTAINED PRIOR TO STARTING CONSTRUCTION.
- 7. ALL ELEVATIONS AND DIMENSIONS SHALL BE VERIFIED BY THE CONTRACTOR PRIOR TO CONSTRUCTION.
- 8. THE CONTRACTOR SHALL BE ULTIMATELY RESPONSIBLE FOR ENSURING THAT ALL WORK IS DONE IN A SAFE AND RESPONSIBLE MANNER.

SURVEY / BOUNDARY NOTES:

- 1. ALL RIGHT-OF-WAY AND PROPERTY LINE INFORMATION WAS ASSIMILATED THROUGH A COMPILATION OF VARIOUS SOURCES INCLUDING BUT NOT LIMITED TO THE STATE OF VERMONT AGENCY OF TRANSPORTATION, TOWN OF WINDSOR, VERMONT TAX MAPPING RECORDS, A CONSTRUCTION PLAN SET PREPARED BY DUFRESNE GROUP DATED MAY 2013, AND FIELD SURVEY DATA FROM VERMONT SURVEY CONSULTANTS, LLC (VSC). INFORMATION SHOWN IS FOR GENERAL LOCATION PURPOSES ONLY. MARBLE VALLEY ENGINEERING, PC WILL NOT BE HELD LIABLE FOR ANY ERRORS AND OMISSIONS WHICH HAVE BEEN INCORPORATED INTO THIS DOCUMENT AS A RESULT OF INFORMATION PROVIDED FROM OTHER SOURCES.
- 2. PRIOR TO CONSTRUCTION, ALL PROPERTY BOUNDARY LINES NEAR THE CONSTRUCTION AREAS (AS A MINIMUM) SHOULD BE ESTABLISHED BY FIELD SURVEY AND CLEARLY MARKED.
- 3. IT IS THE RESPONSIBILITY OF THE CONTRACTOR TO PRESERVE AND PROTECT ALL BOUNDARY MONUMENTATION. IF DAMAGED OR DESTROYED, BOUNDARY MARKERS SHALL BE RESET BY A VERMONT STATE REGISTERED LAND SURVEYOR.
- 4. TOPOGRAPHIC SURVEYS WERE PERFORMED BY VSC IN NOVEMBER & DECEMBER OF 2016, AND IN JANUARY 2017.
- 5. ALL NORTH ARROWS IN THIS PLAN SET REFERENCE GRID NORTH.
- 6. ALL WORK SHALL BE DONE IN PUBLIC RIGHT-OF-WAY OR EASEMENT AREAS.

PEDESTRIAN TEMPORARY TRAFFIC CONTROL NOTES


- 1. THE CONTRACTOR SHALL MAINTAIN PEDESTRIAN THROUGH MOVEMENTS FROM ONE END OF THE CONSTRUCTION AREA TO THE OTHER, ON AT LEAST ONE SIDE OF THE STREET DURING CONSTRUCTION. ANY SIDEWALK CLOSURES SHALL MEET THE REQUIREMENTS OF MUTCD, PART 6.
- 2. PEDESTRIAN ACCESS SHALL BE PROVIDED TO ALL ADJACENT PROPERTIES, BUILDINGS, RESIDENCES, AND COMMERCIAL PROPERTIES AT ALL TIMES. THIS MAY INCLUDE TEMPORARY WALKWAYS SPANNING THE CONSTRUCTION AREA.
- 3. IF SIDEWALKS ARE CLOSED, A TEMPORARY PEDESTRIAN ACCESS ROUTE (TPAR) MAY BE PROVIDED ON THE SAME SIDE OF THE ROAD AS THE CLOSED SIDEWALK, IF POSSIBLE. SIGNS AND BARRICADES SHALL BE USED TO PROVIDE ADVANCE NOTICE OF THE CLOSURE AND THE ROUTE OF ANY PEDESTRIAN DETOURS. THE TPAR SHALL HAVE A MINIMUM UNOBSTRUCTED WIDTH OF FOUR FEET. IF THE TPAR IS LESS THAN FIVE FEET IN WIDTH, THEN A FIVE FOOT BY FIVE FOOT PASSING SPACE SHOULD BE PROVIDED AT LEAST EVERY 200 FEET. THE SURFACE OF THE TPAR SHALL BE SMOOTH AND CONTINUOUS FOR THE LENGTH OF THE TPAR. THE TPAR SHALL MAINTAIN THE SAME LEVEL OF ACCESSIBILITY AND DETECTABILITY AS THE FACILITY THAT IS BEING CLOSED. THE TPAR SHALL NOT LEAD PEDESTRIANS INTO CONFLICTS WITH VEHICLES, EQUIPMENT, OR CONSTRUCTION OPERATIONS.
- 4. IF THE TPAR IS ADJACENT TO MOVING TRAFFIC, CONSTRUCTION OPERATIONS / EQUIPMENT, OR DROP OFFS, THEN CRASH WORTHY CHANNELIZING DEVICES THAT MEET THE REQUIREMENTS OF MUTCD SHALL BE USED.
- 5. THE CONTRACTOR SHALL NOT STORE OR PLACE ANY CONSTRUCTION MATERIALS, EQUIPMENT, OR SIGNS IN THE PEDESTRIAN PATH OF TRAVEL.
- 6. THE CONTRACTOR'S OPERATIONS SHALL NOT OCCUPY SIDEWALKS EXCEPT WHERE PROPER PROTECTION AND A TPAR HAVE BEEN PROVIDED.
- 7. THE CONTRACTOR SHALL PROVIDE A TEMPORARY PEDESTRIAN TRAFFIC CONTROL PLAN FOR REVIEW AND WRITTEN APPROVAL A MINIMUM OF THREE WEEKS BEFORE SUCH A PLAN IS IMPLEMENTED. THIS PLAN SHALL DETAIL THE CONSTRUCTION PHASING AND SCHEDULE AND THE SPECIFIC METHODS OF MAINTAINING SAFE PEDESTRIAN ACCESS THROUGHOUT THE CONSTRUCTION AREA. THIS PLAN SHALL PROVIDE THE LOCATION AND DETAILS OF TEMPORARY CONSTRUCTION SIGNING, MARKINGS, BARRICADES, CHANNELIZING DEVICES, TPARS, AND METHODS TO MAINTAIN ACCESS TO ALL ADJACENT PROPERTIES, BUILDINGS, RESIDENCES, AND COMMERCIAL PROPERTIES.
- 8. SEE VTRANS BICYCLE AND PEDESTRIAN WORK ZONE GUIDE.
- 9. SEE CURRENT VTRANS PEDESTRIAN TPR NOTES.

LEGEND:	
CONTROL POINT	\triangle
GATE VALVE	\bowtie
CURB STOP	⊗
SANITARY SEWER MANHOLE	<u>\$</u>
STORMWATER MANHOLE	0
TELECOMMUNICATION MANHOLE	①
CATCH BASIN (SQUARE)	
CATCH BASIN (ROUND)	⊗
MONITORING WELL	•
UTILITY POLE	-0-
GUY WIRE	←
RAILROAD CROSSING SIGNAL	(})
SIGN	- 0 -
IRON PIPE / ROD	•
MARBLE MONUMENT	
CONCRETE BOLLARD	0
FIRE HYDRANT	
DETECTABLE WARNING PLATE	•••••
PROPERTY LINE	
RIGHT-OF-WAY LINE	
STORMWATER LINE	STM
POTABLE WATER MAIN	W _E
POTABLE WATER SERVICE LINE	WSVC _E
SANITARY SEWER MAIN	S _E
SANITARY SEWER SERVICE LINE	SSVC _E
OVERHEAD ELECTRIC LINE	OHE _E
UNDERGROUND ELECTRIC LINE	UG _E
UNDERGROUND TELECOMMUNICATIONS LINE	T
MAJOR CONTOUR (EXISTING)	
MAJOR CONTOUR (PROPOSED)	465
MINOR CONTOUR (EXISTING)	
MINOR CONTOUR (PROPOSED)	463
,	403
BITUMINOUS CONCRETE PAVED SURFACE	
GRAVEL SURFACE	
CONCRETE SIDEWALK AREA (EXISTING)	
CONCRETE SIDEWALK AREA (PROPOSED)	
VAOT 704.05A COMPACTED CRUSHED GRAVEL	
VAOT 704.04 COMPACTED BANK RUN GRAVEL	
LOAM AND SEED	
GRANITE CURB (PROPOSED)	
GRANITE CURB (EXISTING)	
CHAIN LINK FENCE	
WOOD FENCE	
PROJECT LIMITS	
DECIDUOUS TREE	
DECIDUOUS TREE	
DECIDUOUS TREE CONIFEROUS TREE	
CONIFEROUS TREE	
CONIFEROUS TREE	
CONIFEROUS TREE SHRUB	
CONIFEROUS TREE SHRUB	
CONIFEROUS TREE SHRUB PROPOSED CROSS WALK	
CONIFEROUS TREE SHRUB PROPOSED CROSS WALK	
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CONIFEROUS TREE SHRUB PROPOSED CROSS WALK RAILROAD TRACKS SILT FENCE BARRIER TAPE	
CONIFEROUS TREE SHRUB PROPOSED CROSS WALK RAILROAD TRACKS SILT FENCE BARRIER TAPE STABILIZED CONSTRUCTION ENTRANCE	
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CONIFEROUS TREE SHRUB PROPOSED CROSS WALK RAILROAD TRACKS SILT FENCE BARRIER TAPE STABILIZED CONSTRUCTION ENTRANCE	
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CONIFEROUS TREE SHRUB PROPOSED CROSS WALK RAILROAD TRACKS SILT FENCE BARRIER TAPE STABILIZED CONSTRUCTION ENTRANCE CHECK DAM TOPSOILING FILTER FABRIC INLET PROTECTION	
CONIFEROUS TREE SHRUB PROPOSED CROSS WALK RAILROAD TRACKS SILT FENCE BARRIER TAPE STABILIZED CONSTRUCTION ENTRANCE CHECK DAM TOPSOILING FILTER FABRIC INLET PROTECTION EXCAVATED DROP INLET PROTECTION	• → B → B → B → B · B · B · B · B · B · B
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CONIFEROUS TREE SHRUB PROPOSED CROSS WALK RAILROAD TRACKS SILT FENCE BARRIER TAPE STABILIZED CONSTRUCTION ENTRANCE CHECK DAM TOPSOILING FILTER FABRIC INLET PROTECTION EXCAVATED DROP INLET PROTECTION TEMPORARY / PERMANENT SEEDING MULCHING FIBER ROLL	→ B N B N B N B N B N B N B N B N B N B

VEGETATION PROTECTION WITH SILT FENCE OR CONSTRUCTION FENCE

ABBREVIATIONS KEY:

			<u> </u>
APPROX	- APPROXIMATE	IN	- INCHES
AVE	- AVENUE	INV	- INVERT
BIT	- BITUMINOUS	IPF	- IRON PIN / PIPE FOUND
BLDG	- BUILDING	LOD	- LIMITS OF DISTURBANCE
_		MAT'L	
BM	- BENCHMARK	MAX	
BOC	- BOTTOM OF CURB	MH	- MANHOLE
BOTT	- BOTTOM	MIN	- MINIMUM
СВ	- CATCH BASIN	N N/E	- NORTH - NOW OR FORMERLY
CF	- CUBIC FEET	N/F NIC	- NOT IN CONTRACT
CI	- CAST IRON	NO.	- NUMBER
ę	- CENTERLINE	NTS	- NOT TO SCALE
CMP	- CORRUGATED METAL PIPE	OC	- ON CENTER
C/O	- CLEANOUT	<u> የ</u>	- PROPERTY LINE
CONC	- CONCRETE	PL	- PROJECT LIMITS
		PP	- POWER POLE
CONN	- CONNECT or CONNECTION	PSI	- POUNDS PER SQUARE INCH
CONST	- CONSTRUCTION	PVMT	- PAVEMENT
CS	- CURB STOP	R	- RADIUS
CTR	- CONTRACTOR	RCP	- REINFORCED CONCRETE PIPE
X-ING	- CROSSING	REINF	- REINFORCING or REINFORCED
CU	- COPPER	REQ'D	- REQUIRED
CULV	- CULVERT	RET	- RETAINER or RETAINING
D	- DEPTH	ROW	- RIGHT-OF-WAY
EG	- EXISTING GROUND	RR	- RAILROAD
ELEC	- ELECTRIC or ELECTRICAL	S	- SOUTH
EL or ELEV	- ELEVATION	SIP	- SPIKE IN POLE
EPSC	- EROSION PREVENTION	SIR	
	& SEDIMENT CONTROL	ST	- STREET
ETC.		STA	
EXIST	- EXISTING	SW	- SIDEWALK
f'c	- CONCRETE COMPRESSIVE	TB TBM	- THRUST BLOCK
50	STRENGTH	THK	- TEMPORARY BENCH MARK - THICK
FG	- FINISH GROUND	TOC	- TOP OF CURB
FT	- FOOT OR FEET	TYP	- TYPICAL
GAL.	- GALLONS		- UNDERGROUND
GRND	- GROUND	UG	
GRVL	- GRAVEL	UON	- UNLESS OTHERWISE NOTED
H	- HORIZONTAL or HIGH	VAOT	- VERMONT AGENCY OF TRANSPORTATION (VTRANS)
HDPE	- HIGH DENSITY POLYETHYLENE	W/	- WITH
HORIZ	- HORIZONTAL	WSO	- WATER SHUT-OFF
HYD	- HYDRANT	WWM	- WELDED WIRE MESH

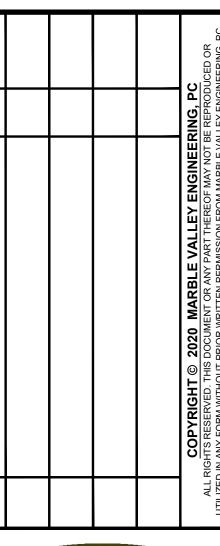



WWW.MARBLEVALLEYENGINEERING.COM



CIVIL ENGINE

ANS FOR CONSTRUCTION OF SOR TCSP TSCE (008) (NDSOR STREETSCAPES WINDSOR, VERMONT

PROJECT NO.: M1104


DRAWN BY: PGF / SMC / RML

DATE: FEBRUARY 20, 2020

SCALE: NONE

SHEET: G002

				QUAN	ITITY SHEET				
SUMMARY OF ESTIMATED QUANTITIES			ESTIMATED QUANTITIES	TOTALS 1011	DESCRIPTIONS		DETAILED SUMMARY OF QUAN		
OGUE ER				GRAND FINAL UN	NIT ITEMS	ITEM NUMBER	ROUND QUANTITIE UNIT ITEMS		
					CY COMMON EXCAVATION	203.15			
				1.00 C	UNCLASSIFIED EXCAVATION (CONTINGENCY)	203.17			
				96.00 C	CY EXCAVATION OF SURFACES AND PAVEMENT	203.28			
					CY SAND BORROW (CONTINGENCY)	203.31			
				410.00 S	COLD PLANING, BITUMINOUS PAVEMENT	210.10			
				110.00 C	CY SUBBASE OF GRAVEL	301.15			
				160.00 C	SUBBASE OF CRUSHED GRAVEL, FINE GRADED	301.26			
				20.00	CY AGGREGATE SURFACE COURSE	401.10			
				80.00 To	ON MARSHALL BITUMINOUS CONCRETE PAVEMENT	406.25			
				5.00 C	CY CONCRETE, CLASS B (CONTINGENCY)	541.25			
				3.00 E	EA CHANGING ELEVATION OF DROP INLETS, CATCHBASINS OR MANHOLES	604.40			
				1.00 E	EA CAST IRON GRATE WITH FRAME, TYPE B (MODIFIED WITH CURB INLET)	604.46			
				10.00 C	CY STONE FILL, TYPE I	613.10			
				550.00 L	LF VERTICAL GRANITE CURB	616.21			
				234.00 L	LF REMOVAL OF EXISTING CURB	616.41			
				65.00 To	ON BITUMINOUS CONCRETE GUTTERS AND TRAFFIC ISLANDS	616.47			
				1.00 E	RELOCATE MAILBOX, SINGLE SUPPORT (CONTINGENCY)	617.10			
				275.00 S	PORTLAND CEMENT CONCRETE SIDEWALK, 5 INCH	618.10			
				25.00 S	SY PORTLAND CEMENT CONCRETE SIDEWALK, 8 INCH	618.11			
				30.00	DETECTABLE WARNING SURFACE	618.30			
				120.00 L	LF REMOVING AND RESETTING FENCE	620.50			
				200.00 H	R FLAGGERS	630.15			
				1.00 L	S MOB / DEMOB	635.11			
				1.00 L	LS TRAFFIC CONTROL	641.10			
				20.00	SY GEOTEXTILE FOR ROADBED SEPARATOR	649.11			
				40.00 S	GEOTEXTILE UNDER STONE FILL	649.31			
				10.00 L	_B SEED	651.15			
				100.00 L	_B FERTILIZER	651.18			
				100.00 C	CY TOPSOIL	651.35			
					ON HAY MULCH	653.10			
				0.50 To	ON ROLLED EROSION CONTROL PRODUCT TYPE I	653.20			
				15.00 C	CY STABILIZED CONSTRUCTION ENTRANCE	653.35			
				3.00 E	EA INLET PROTECTION DEVICE, TYPE II	653.41			
				130.00 L	LF SILT FENCE TYPE II	653.476			
				1130.00 L	LF BARRIER FENCE	653.50			
				20.00 L	LF EROSION LOG (CONTINGENCY)	653.60			
				1.00 E	TRANSPLANTING SHRUBS (CONTINGENCY)	656.50			
				1.00 L	LS TREE PROTECTION	656.85			
				1.00 E	EA REMOVING SIGNS (CONTINGENCY)	675.50			
					EA RESETTING SIGNS (CONTINGENCY)	675.60			
				10.00 L	LF TRENCH DRAIN	900.540			
				20.00 L	LF 6 FOOT FENCE, VARIOUS MATERIALS (CONTINGENCY)	900.541			

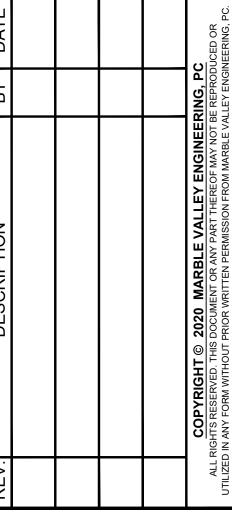



GROVE STREET, RUTLAND, VERMONT W.MARBLEVALLEYENGINEERING.COM



CIVIL ENGINEER


WINDSOR TCSP TSCE (008) C/3
WINDSOR STREETSCAPES
WINDSOR, VERMONT

ROJECT NO.: M1104 RAWN BY: PGF/SMC/RML


CALE: NONE


ATE: FEBRUARY 20, 2020

SHEET: G003

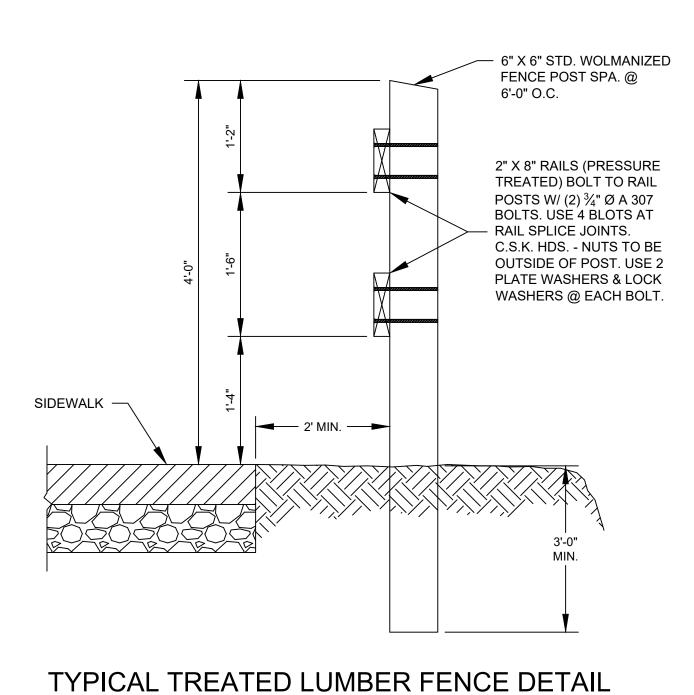

NOT TO SCALE

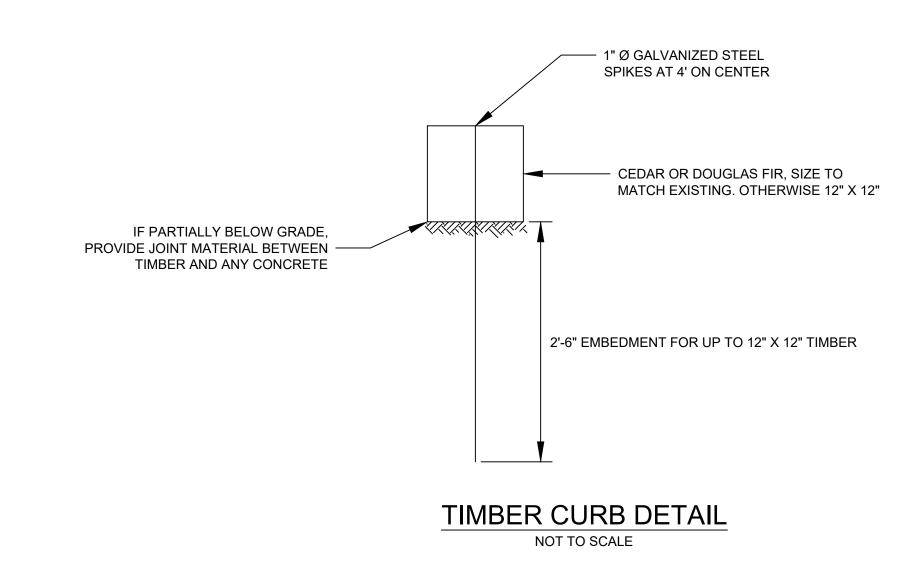

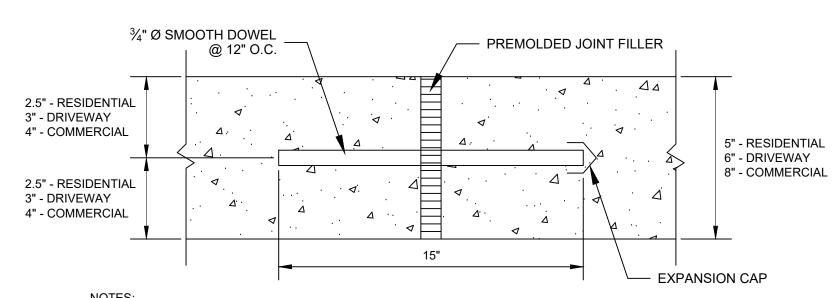

1. ALL NEW OR REPLACEMENT CONCRETE SIDEWALK SHALL BE DOWELED INTO EXISTING CONCRETE PAVEMENT
2. REMOVE EXISTING SIDEWALK BACK TO NEAREST EXPANSION OR SAWCUT JOINT

CONCRETE DOWEL

NOT TO SCALE

SEE NOTE 4 5" EXPANSION JOINT TO ENGINEER'S DETAIL (SEE NOTE 5) CONCRETE (SEE NOTE 1) BEDDING LAYER 4" 4"

NOTES:

- 1. A MINIMUM CONCRETE STRENGTH OF 3,500 PSI IS RECOMMENDED. THE
- CONCRETE SHOULD BE VIBRATED TO ELIMINATE AIR POCKETS.

 2. THE FINISHED LEVEL OF THE CONCRETE SURROUND SHOULD BE APPROX. 1/8"
- ABOVE THE TOP OF THE CHANNEL EDGE.

 3. EXPANSION AND CRACK CONTROL JOINTS ARE RECOMMENDED TO PROTECT
- THE CHANNEL AND THE CONCRETE SURROUND.
- STANLESS STEEL, HEEL-SAFE (ANTI-SLIP) GRATE SUITABLE FOR WHEELCHAIRS, HIGH HEELS, BICYCLES, AND PEOPLE WITH CANES.
- EXPANSION JOINTS SHALL BE PROVIDED EACH SIDE SAME AS THOSE IN
- SIDEWALK AT 20 FOOT CENTERS.

 6. LOAD CLASS B 2,670 POUND WHEEL LOAD.

TRENCH DRAIN DETAIL NOT TO SCALE

VTRANS STANDARD SHEETS

SHEET#	<u>TITLE</u>	<u>DATE</u>
C-2A	PORTLAND CEMENT CONCRETE SIDEWALK DRIVE ENTRANCES WITH SIDEWALK ADJACENT TO CURB	10-14-05
C-2B	PORTLAND CEMENT CONCRETE SIDEWALK DRIVE ENTRANCES WITH GREEN STRIP	10-14-05
C-3A	SIDEWALK RAMPS	3-10-08
C-3B	SIDEWALK RAMPS AND MEDIAN ISLANDS	3-10-08
C-10	CURBING	2-11-08
E-121	STANDARD SIGN PLACEMENT CONVENTIONAL ROAD	8-8-95

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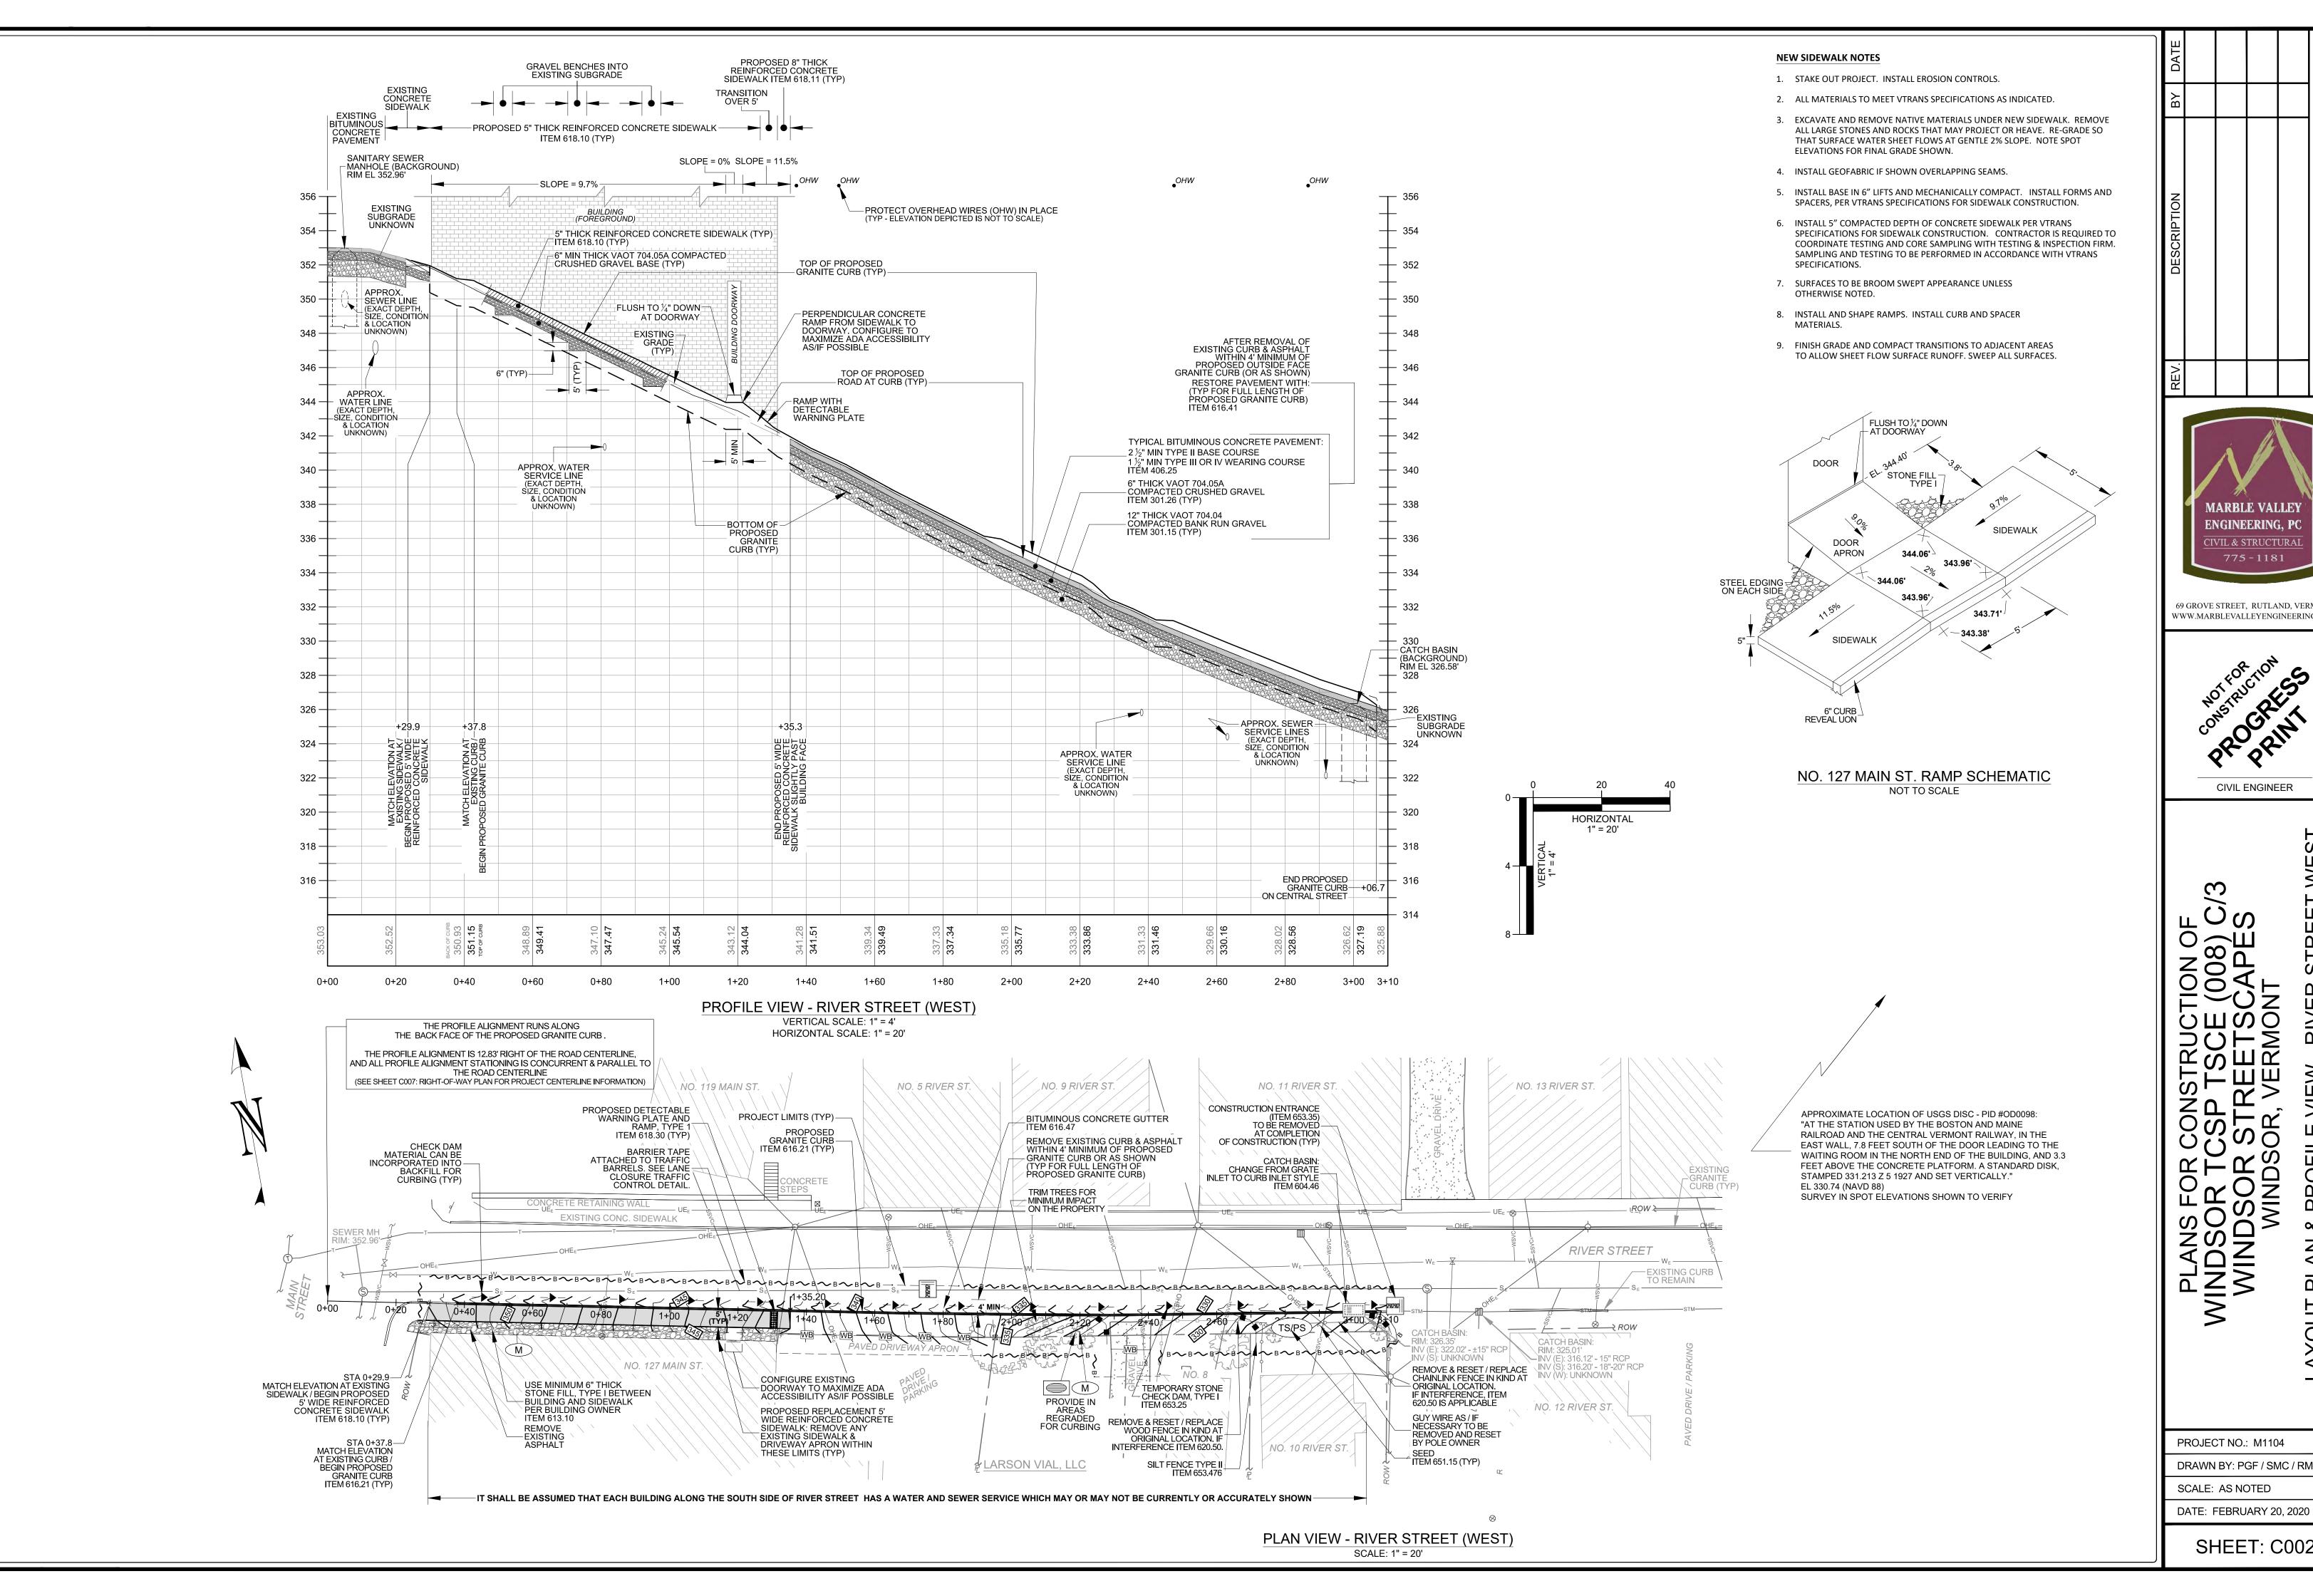


NSTRUCTION OF P TSCE (008) C/3 TREETSCAPES R, VERMONT

PROJECT NO.: M1104

DRAWN BY: SMC / RML
SCALE: NONE

DATE: FEBRUARY 20, 2020





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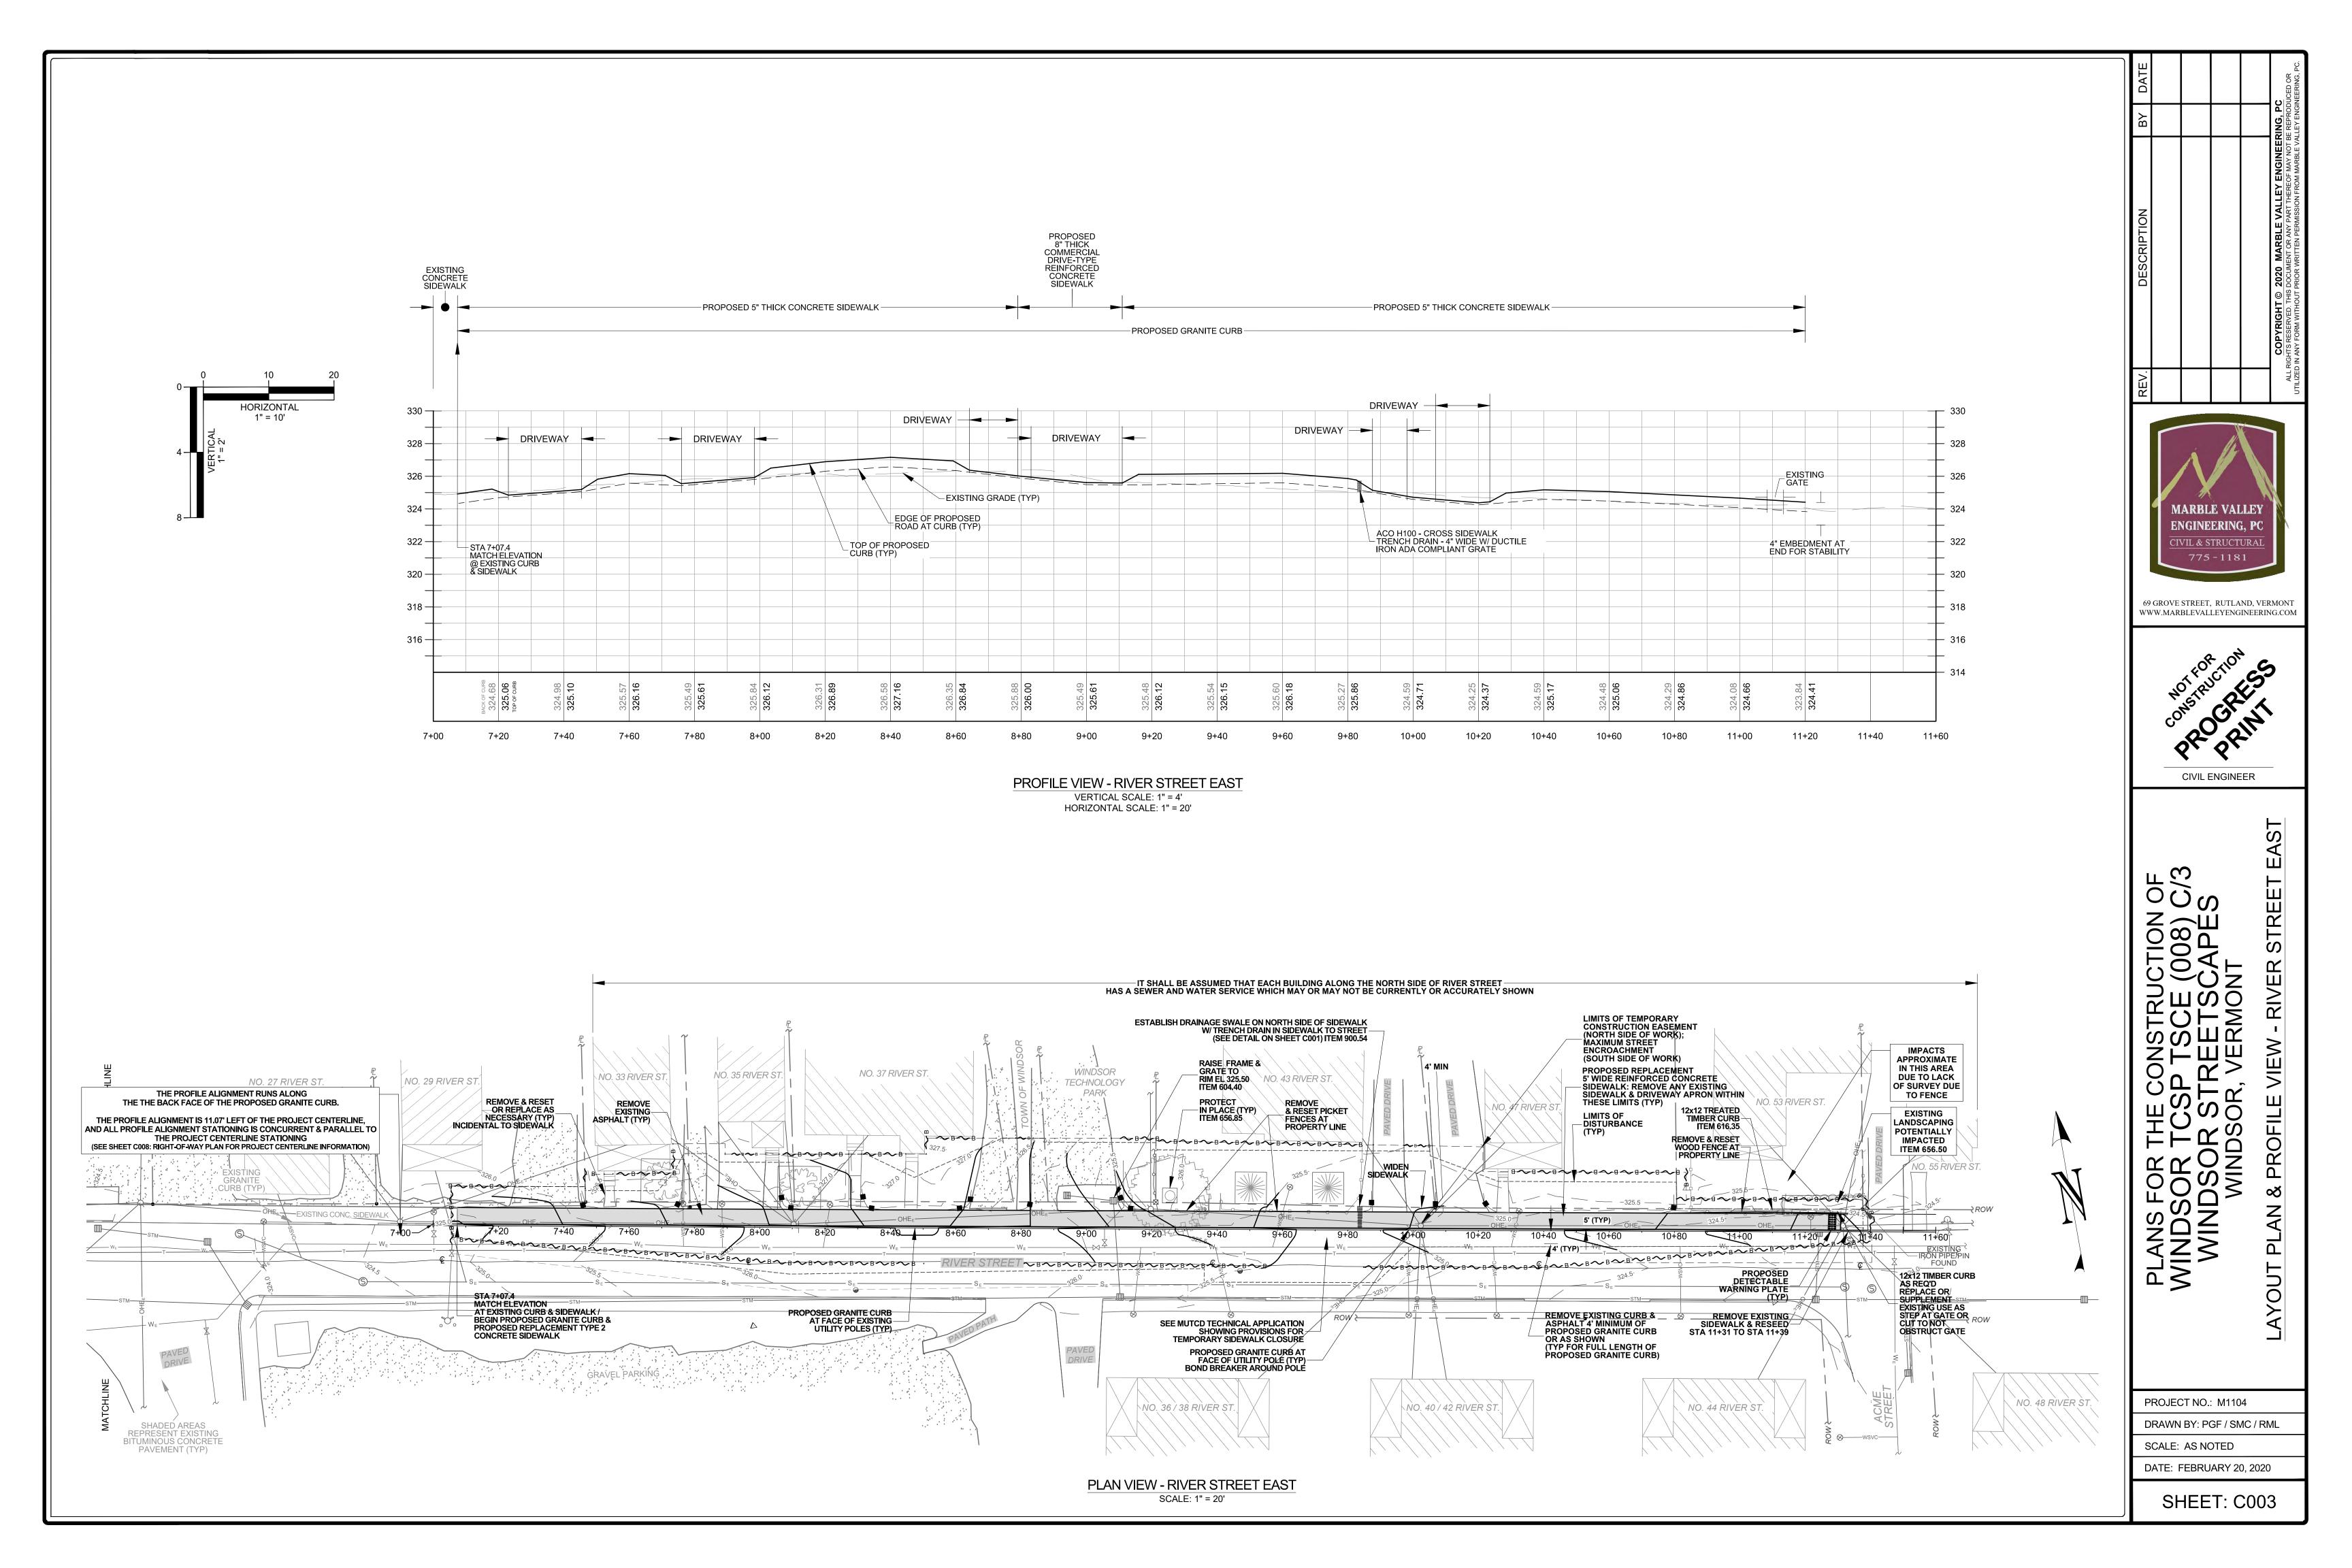



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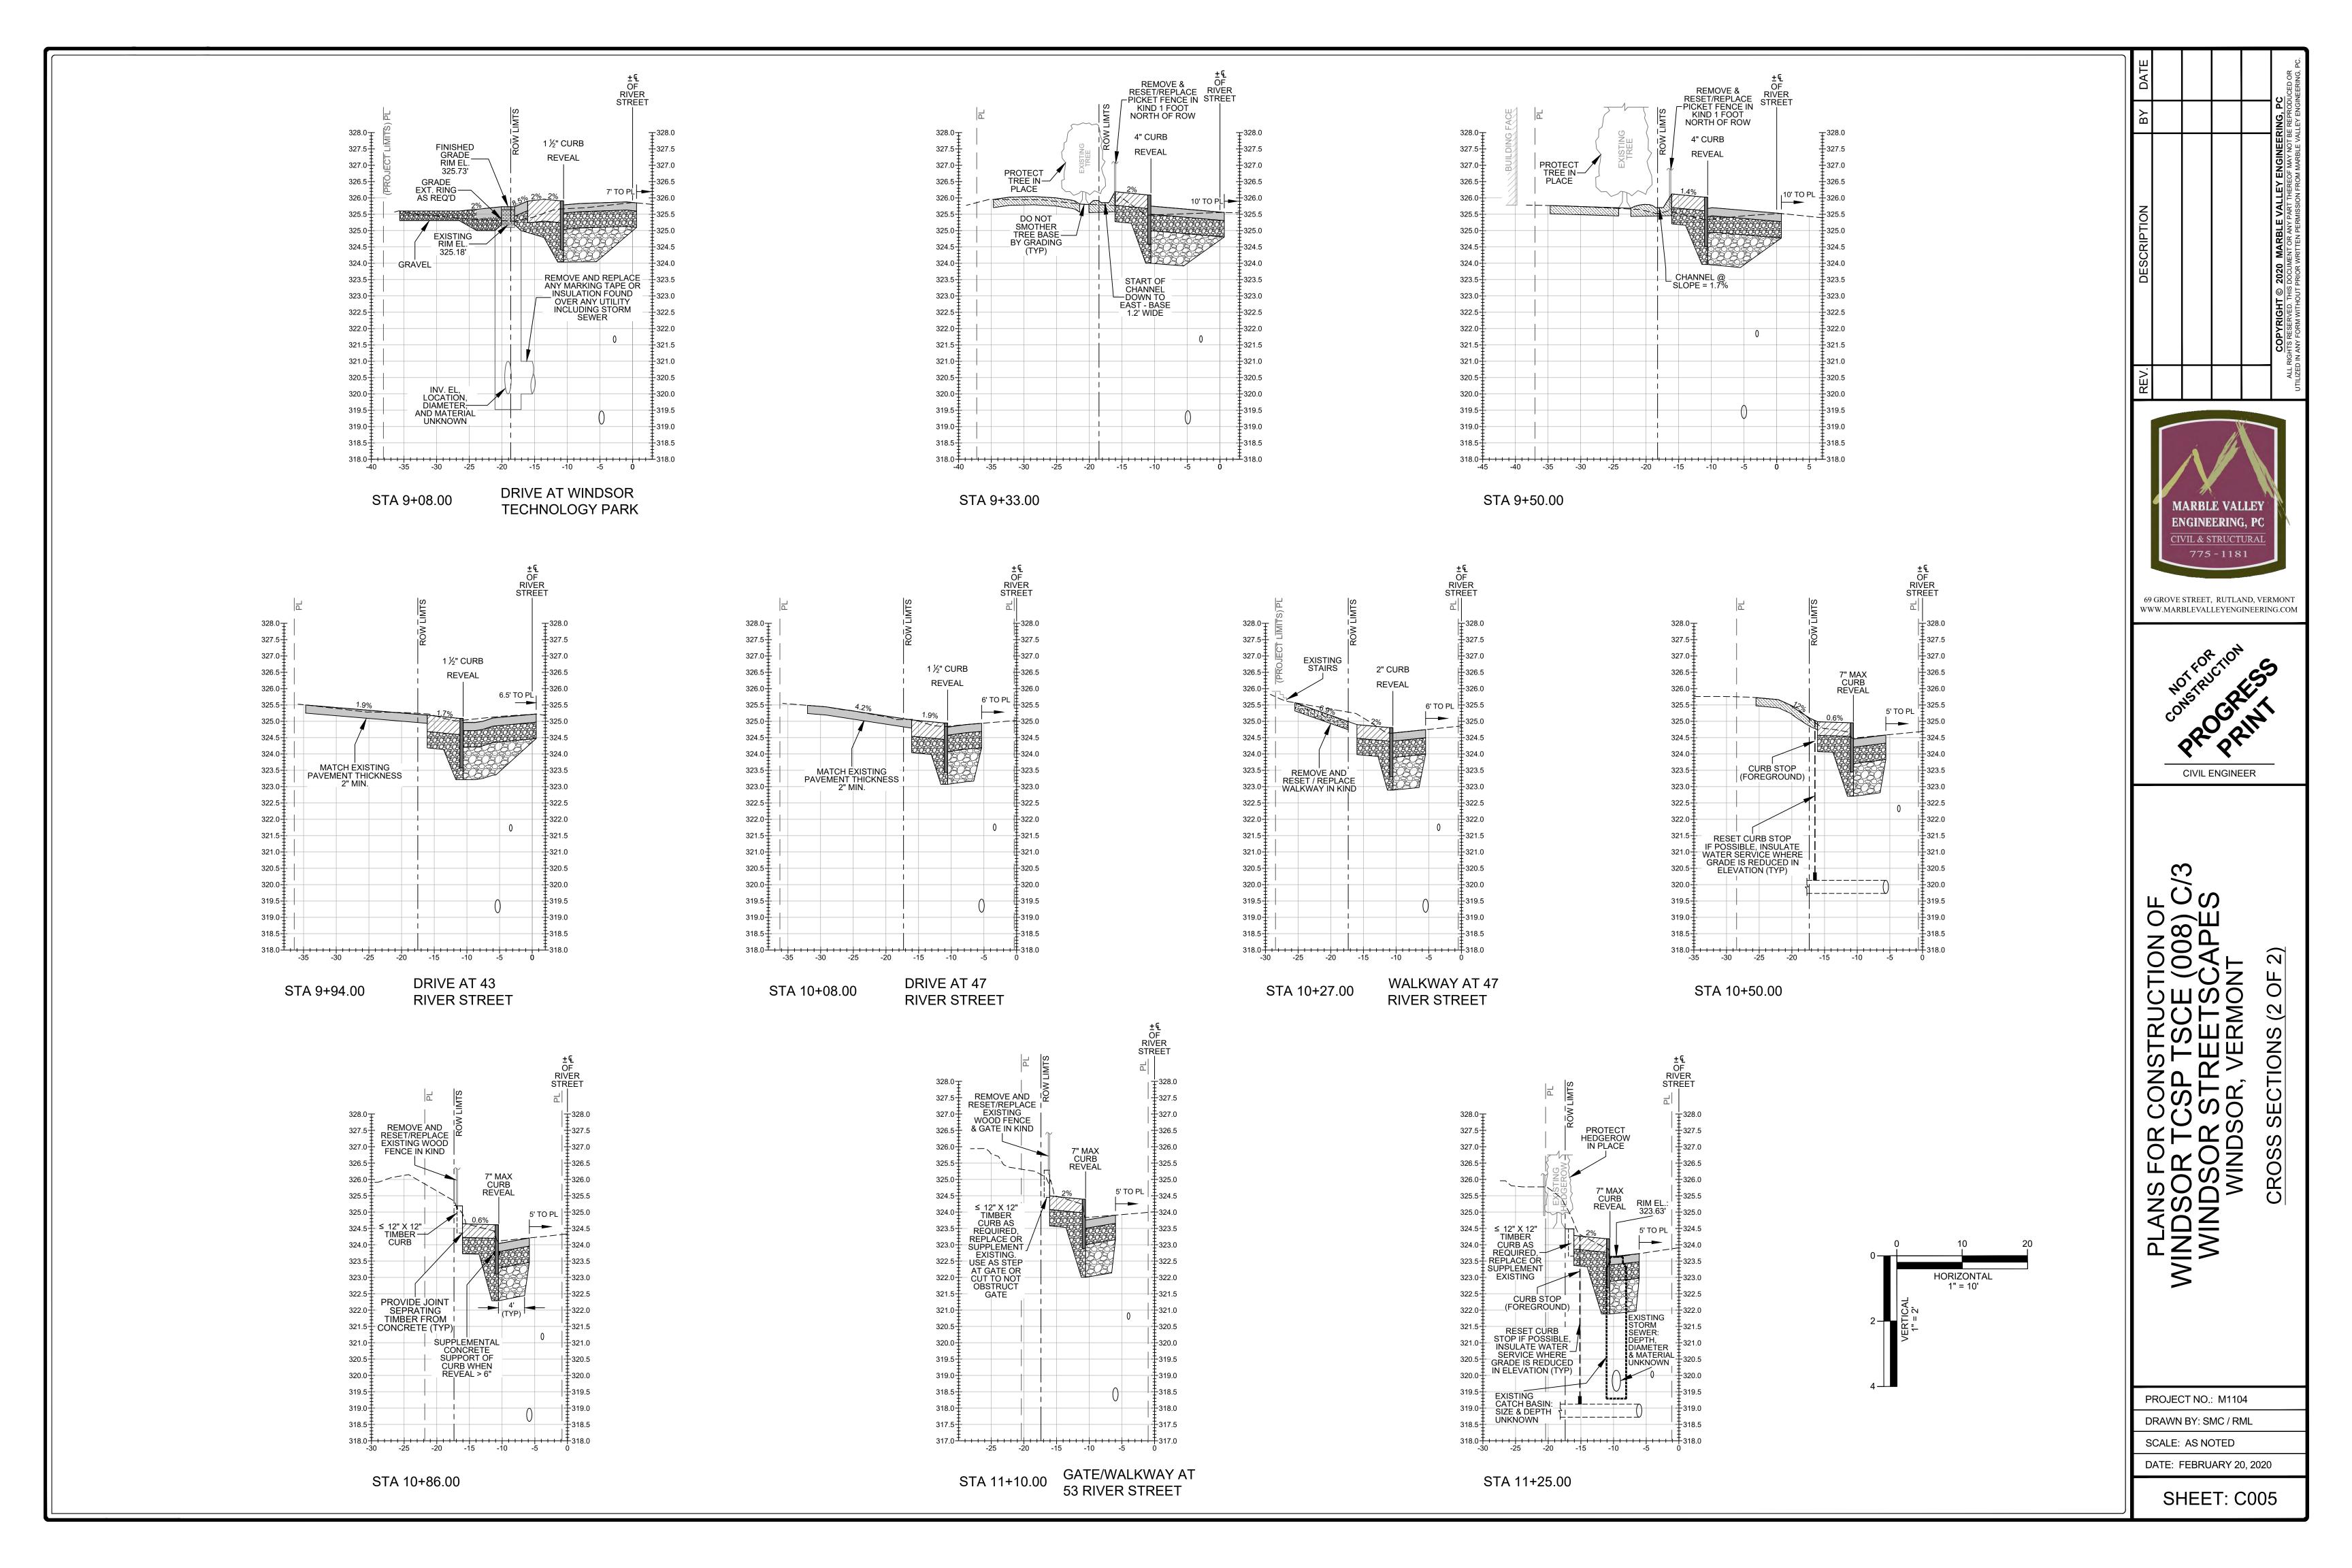
PROJECT NO.: M1104


DRAWN BY: PGF / SMC / RML

SCALE: AS NOTED





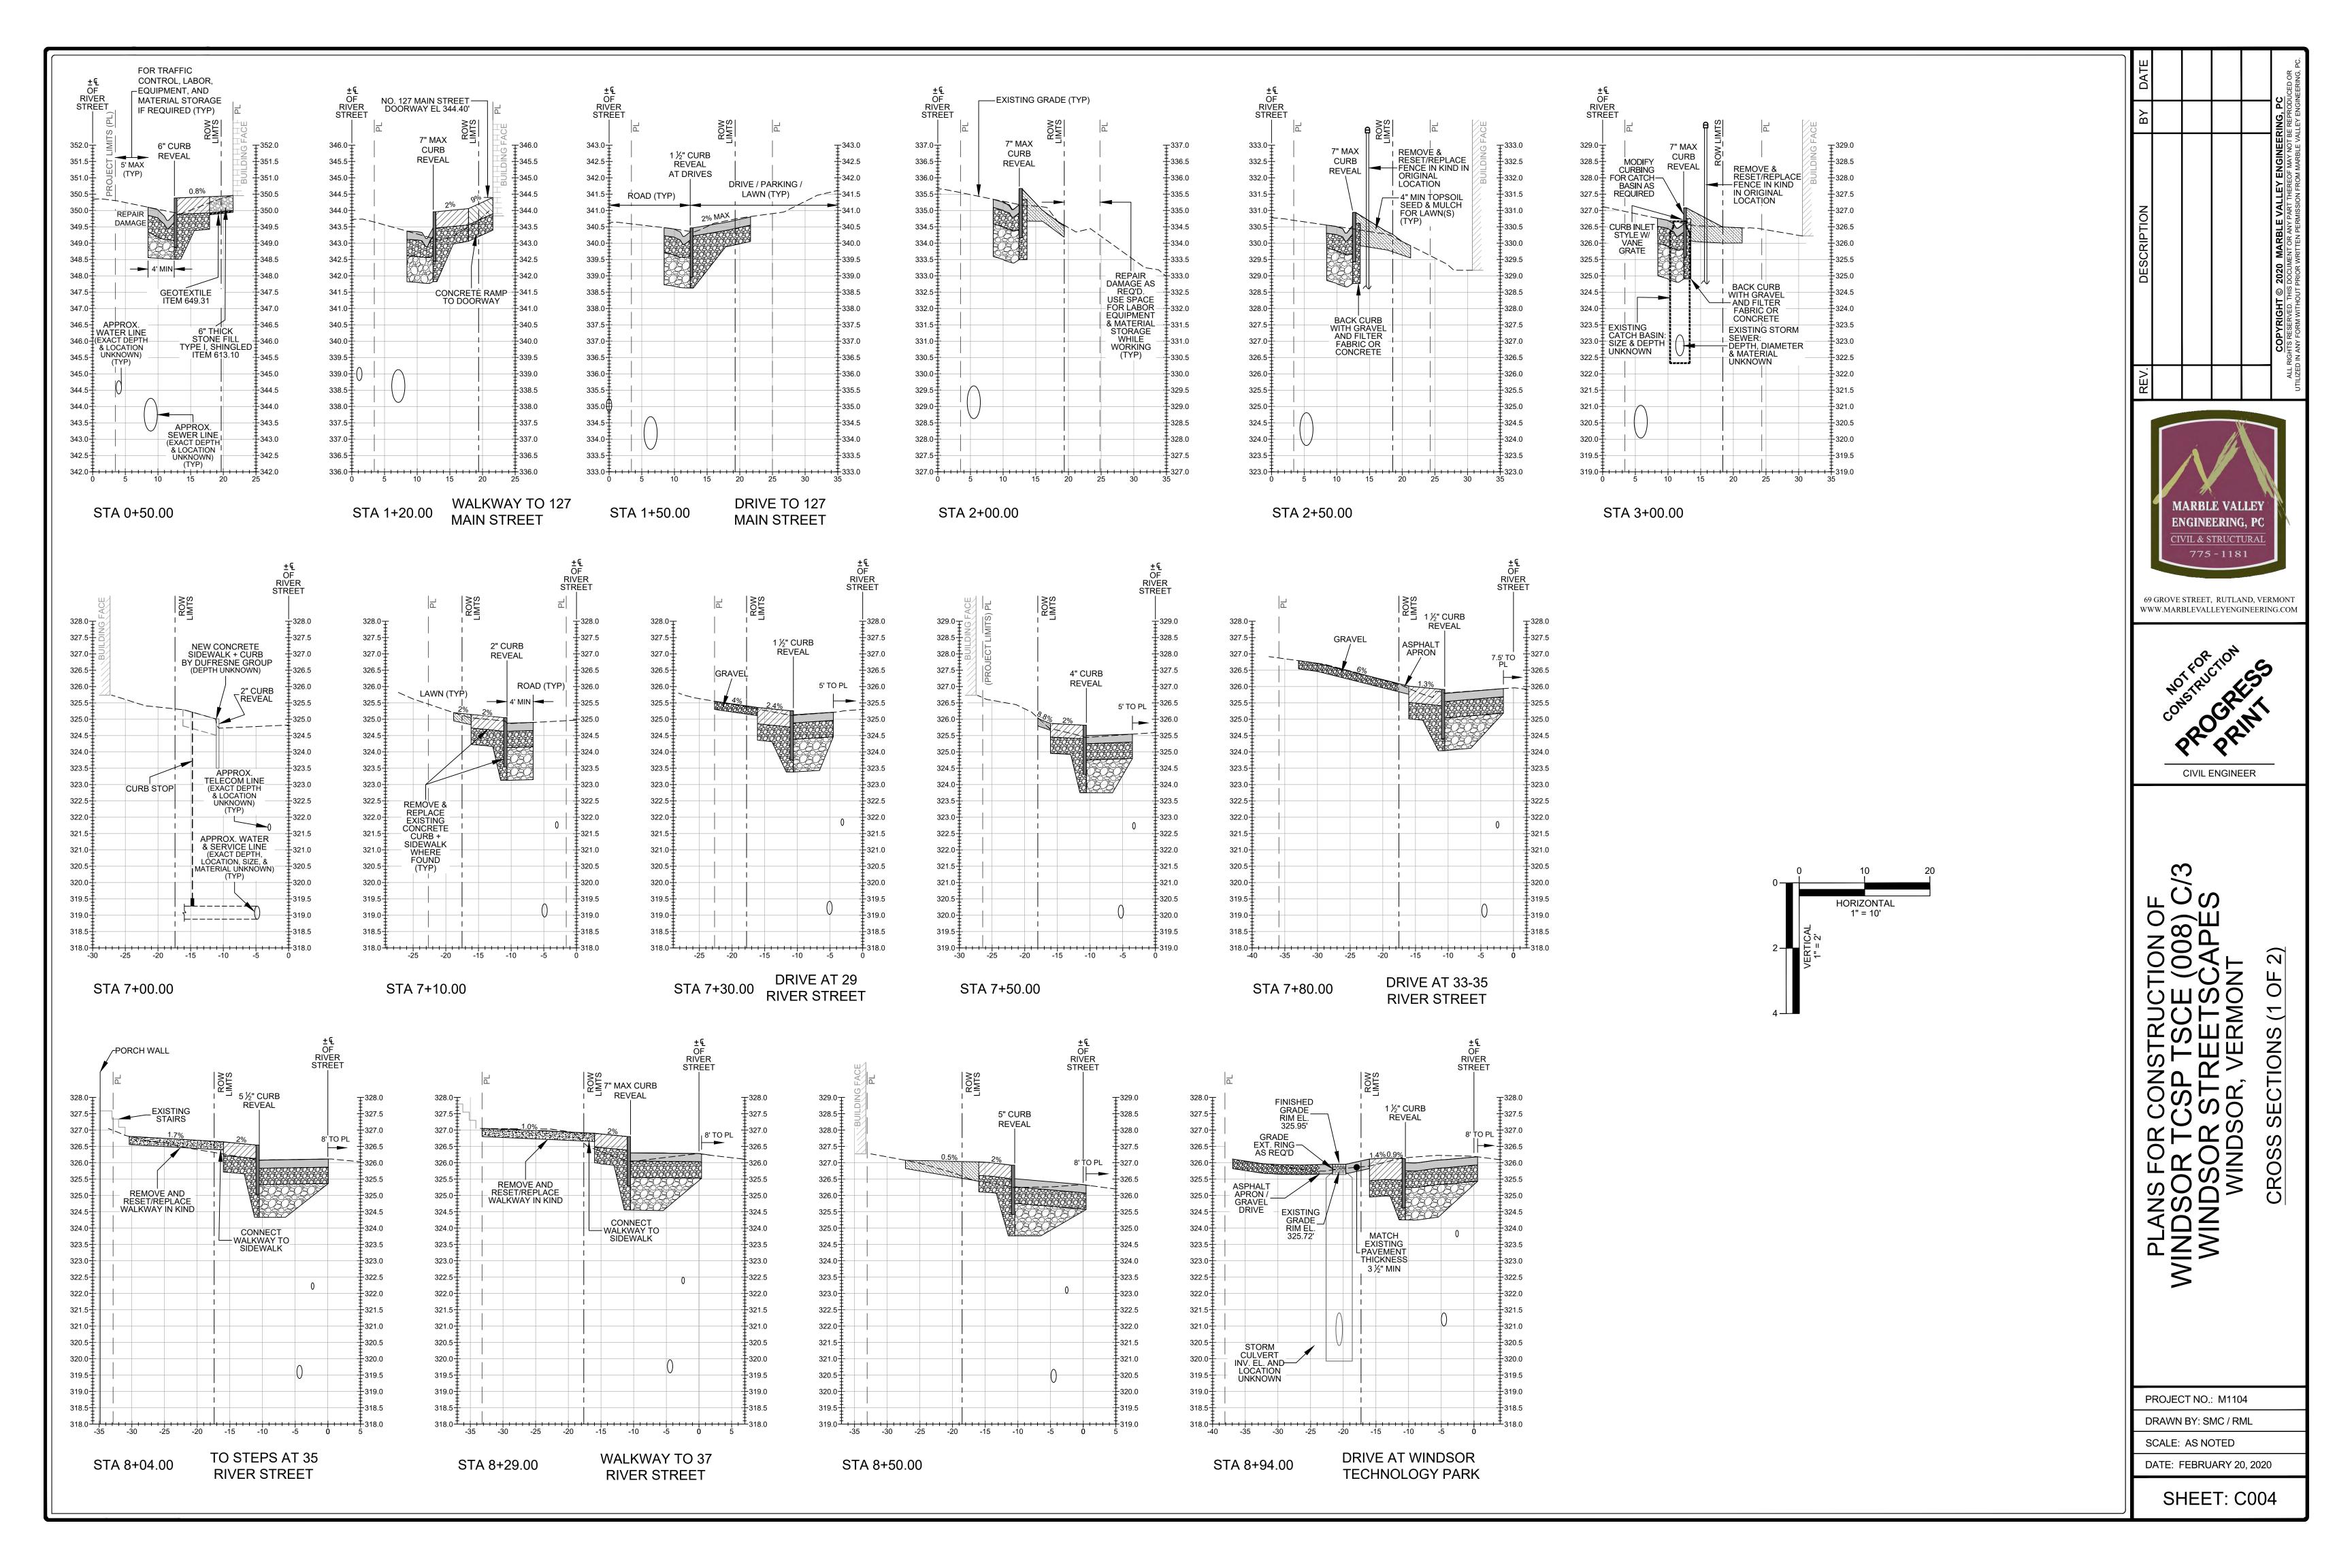

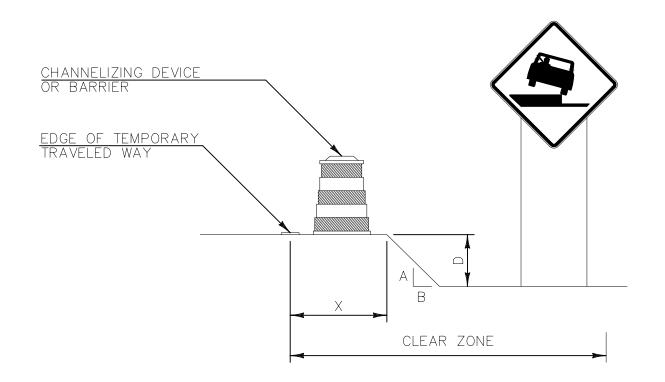


40 MPH OR LESS WITH VERTICAL CURB

X (FEET)	DROP (D) (INCHES)	DEVICE REQUIRED		
0-10'	LESS THAN OR EQUAL TO 12"	NONE		
0-10'	GREATER THAN 12"	CHANNELIZING DEVICE		
GREATER THAN 10'	ANY	NONE		

CHANNELIZING DEVICES MAY BE USED INSTEAD OF BARRIER FOR SHORT TERM OPERATIONS, AND SHOULD BE PLACED TO MAXIMIZE THE WIDTH OF THE TRAVELED WAY.

DROP-OFF ADJACENT TO TRAVELED WAY

NOT TO SCALE

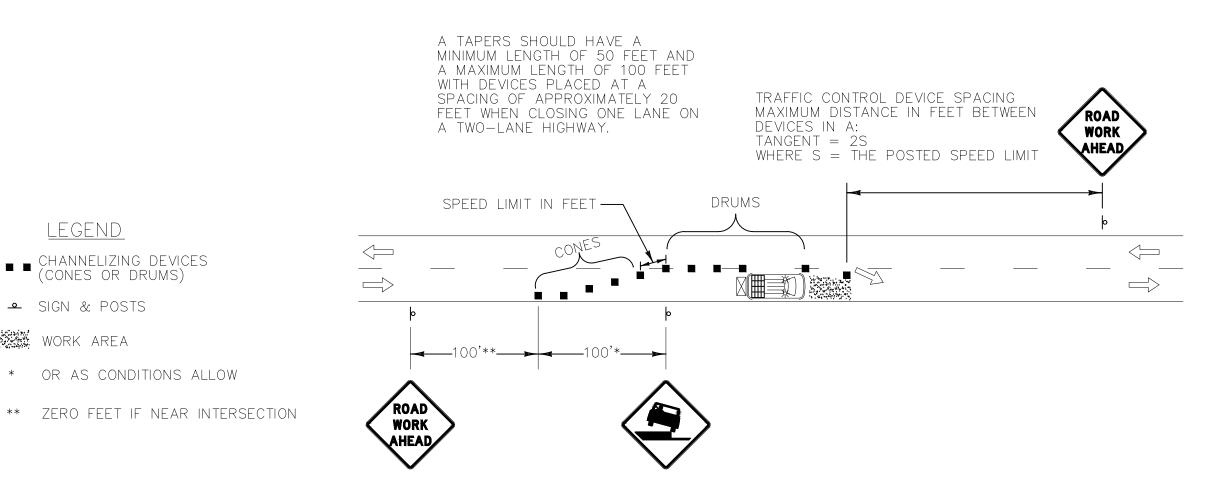

LANE CLOSURE — TWO LANE RESIDENTIAL STREET LOW VOLUME TRAFFIC

NOT TO SCALE

GENERAL NOTES:

LEGEND

SIGN & POSTS

WORK AREA

■ CHANNELIZING DEVICES (CONES OR DRUMS)

* OR AS CONDITIONS ALLOW

- 1. THESE CONDITIONS AND TREATMENTS ARE ONLY PART OF THE TRAFFIC CONTROL SYSTEM AND SHOULD BE USED IN ADDITION TO THE PROPER WORK ZONE SIGNING.
- 2. THE FOLLOWING ARE "MANUAL ON UNIFORM TRAFFIC CONTROL DEVICES" (MUTCD) COMPLIANT CHANNELIZING DEVICES:

A. VERTICAL PANEL B. TYPE | OR TYPE | | BARRICADE C. PLASTIC DRUM D. CONE - WHERE APPLICABLE E. TUBULAR MARKERS


IF CHANNELIZING DEVICES ARE REQUIRED TO STAY IN PLACE DURING NIGHTTIME HOURS, THEY SHALL BE STABILIZED WHILE UNATTENDED IN ACCORDANCE WITH THE MUTCD.

3. CHANNELIZING DEVICE SPACING ALONG A LONGITUDINAL DROP-OFF (TANGENT) SHALL BE AS FOLLOWS:

TANGENT — CHANNELIZING DEVICES SHALL BE SPACED "2S" ("S" IS EQUAL TO THE POSTED SPEED LIMIT IN FEET) APART.

NOTES:


- 1. COMMUNICATIONS AND ACCOMMODATIONS FOR POSTAL DELIVERS, NEWSPAPER ROUTES, TRASH SERVICES AND/OR OTHER DELIVERY SERVICES INTERRUPTED BY THE PROJECT OR DETOUR SHOULD BE COMMUNICATED WITH THE PROPER CONTACTS.
- 2. ALL REASONABLE EFFORTS SHALL BE MADE TO ACCOMMODATE PEDESTRIAN AND BICYCLE TRAVEL. TRAFFIC CONTROL PLANS SHOULD REPLICATE THE EXISTING PEDESTRIAN PATHWAY AS NEARLY AS PRACTICAL. THIS CAN INCLUDE BUT IS NOT LIMITED TO A DEDICATED PEDESTRIAN ESCORT (NOT A FLAGGER ON DUTY), SIGNAGE, AND PEDESTRIAN CHANNELIZING DEVICE WALKWAYS THAT MEET ADA REQUIREMENTS OR HAVE BICYCLIST FOLLOW THE RULES OF THE ROAD JUST LIKE A MOTORIST. ALSO, TO ENSURE THAT OBSTACLES, EQUIPMENT, CONSTRUCTION MATERIALS, TRAFFIC CONTROL DEVICES, ETC. DO NOT ENCROACH INTO THE BICYCLE PATH OF TRAVEL AND THAT THESE ROUTES ARE FREE OF RUTS, SAND AND MUD TO PREVENT CYCLIST'S CRASHES.
- 3. THE CONTRACTOR SHALL PROVIDE ACCESS THROUGH THE WORK ZONE FOR EMERGENCY VEHICLES OR COORDINATE EMERGENCY ROUTES PRIOR TO THE START OF CONSTRUCTION.
- 4. WHEN SCHOOL IS IN SESSION, SCHOOL BUS STOP ACCOMMODATIONS ARE REQUIRED. LOCATIONS SHALL BE COORDINATED WITH THE LOCAL SCHOOL TRANSPORTATION COORDINATOR. ADDITIONAL FLAGGERS WILL BE STATIONED AT THESE LOCATIONS DURING TYPICAL MORNING PICK-UP AND AFTERNOON DROP-OFF TIME PERIODS WHILE WORK IS PERFORMING IN THESE AREAS.

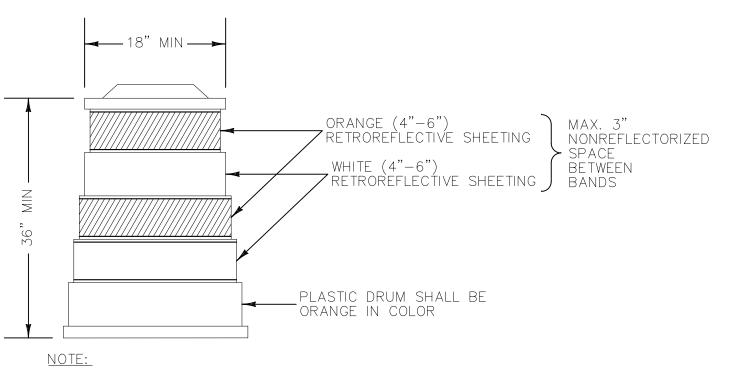

SAND BAGS OR AN APPROPRIATE BALLASTING DEVICE, WHICH DOES NOT PRESENT A HAZARD TO THE IMPACTING VÉHICLE OR BECOME A PROJECTILE UPON IMPACT, SHALL BE USED TO WEIGHT DRUMS. RETROREFLECTIVE SHÉETING SHALL BE ASTM TYPE III OR TYPE VI.

REFLECTORIZED PLASTIC DRUM

NOT TO SCALE

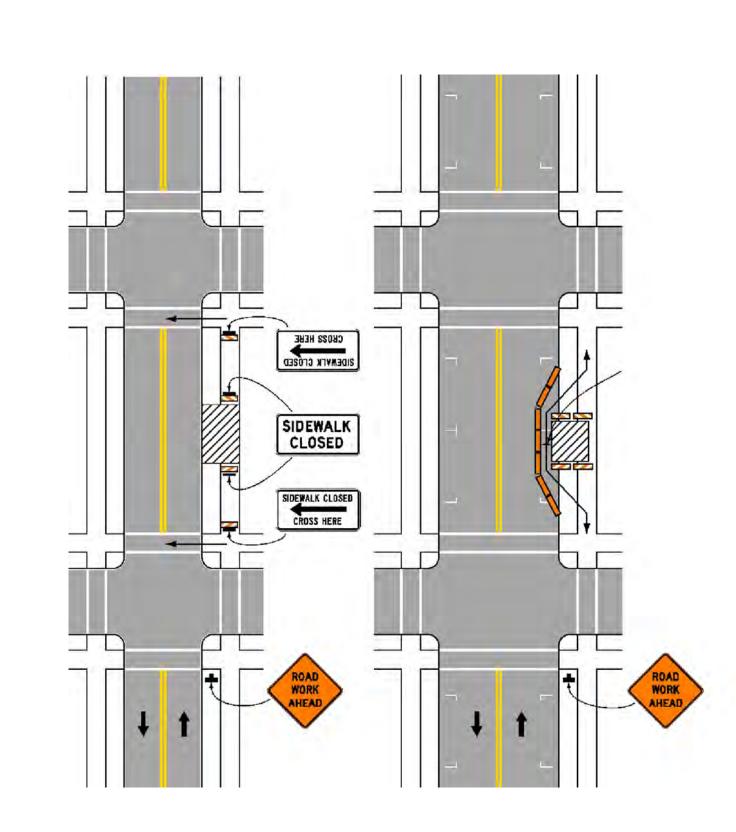


SIDEWALK DETOUR OR DIVERSION

NOT TO SCALE



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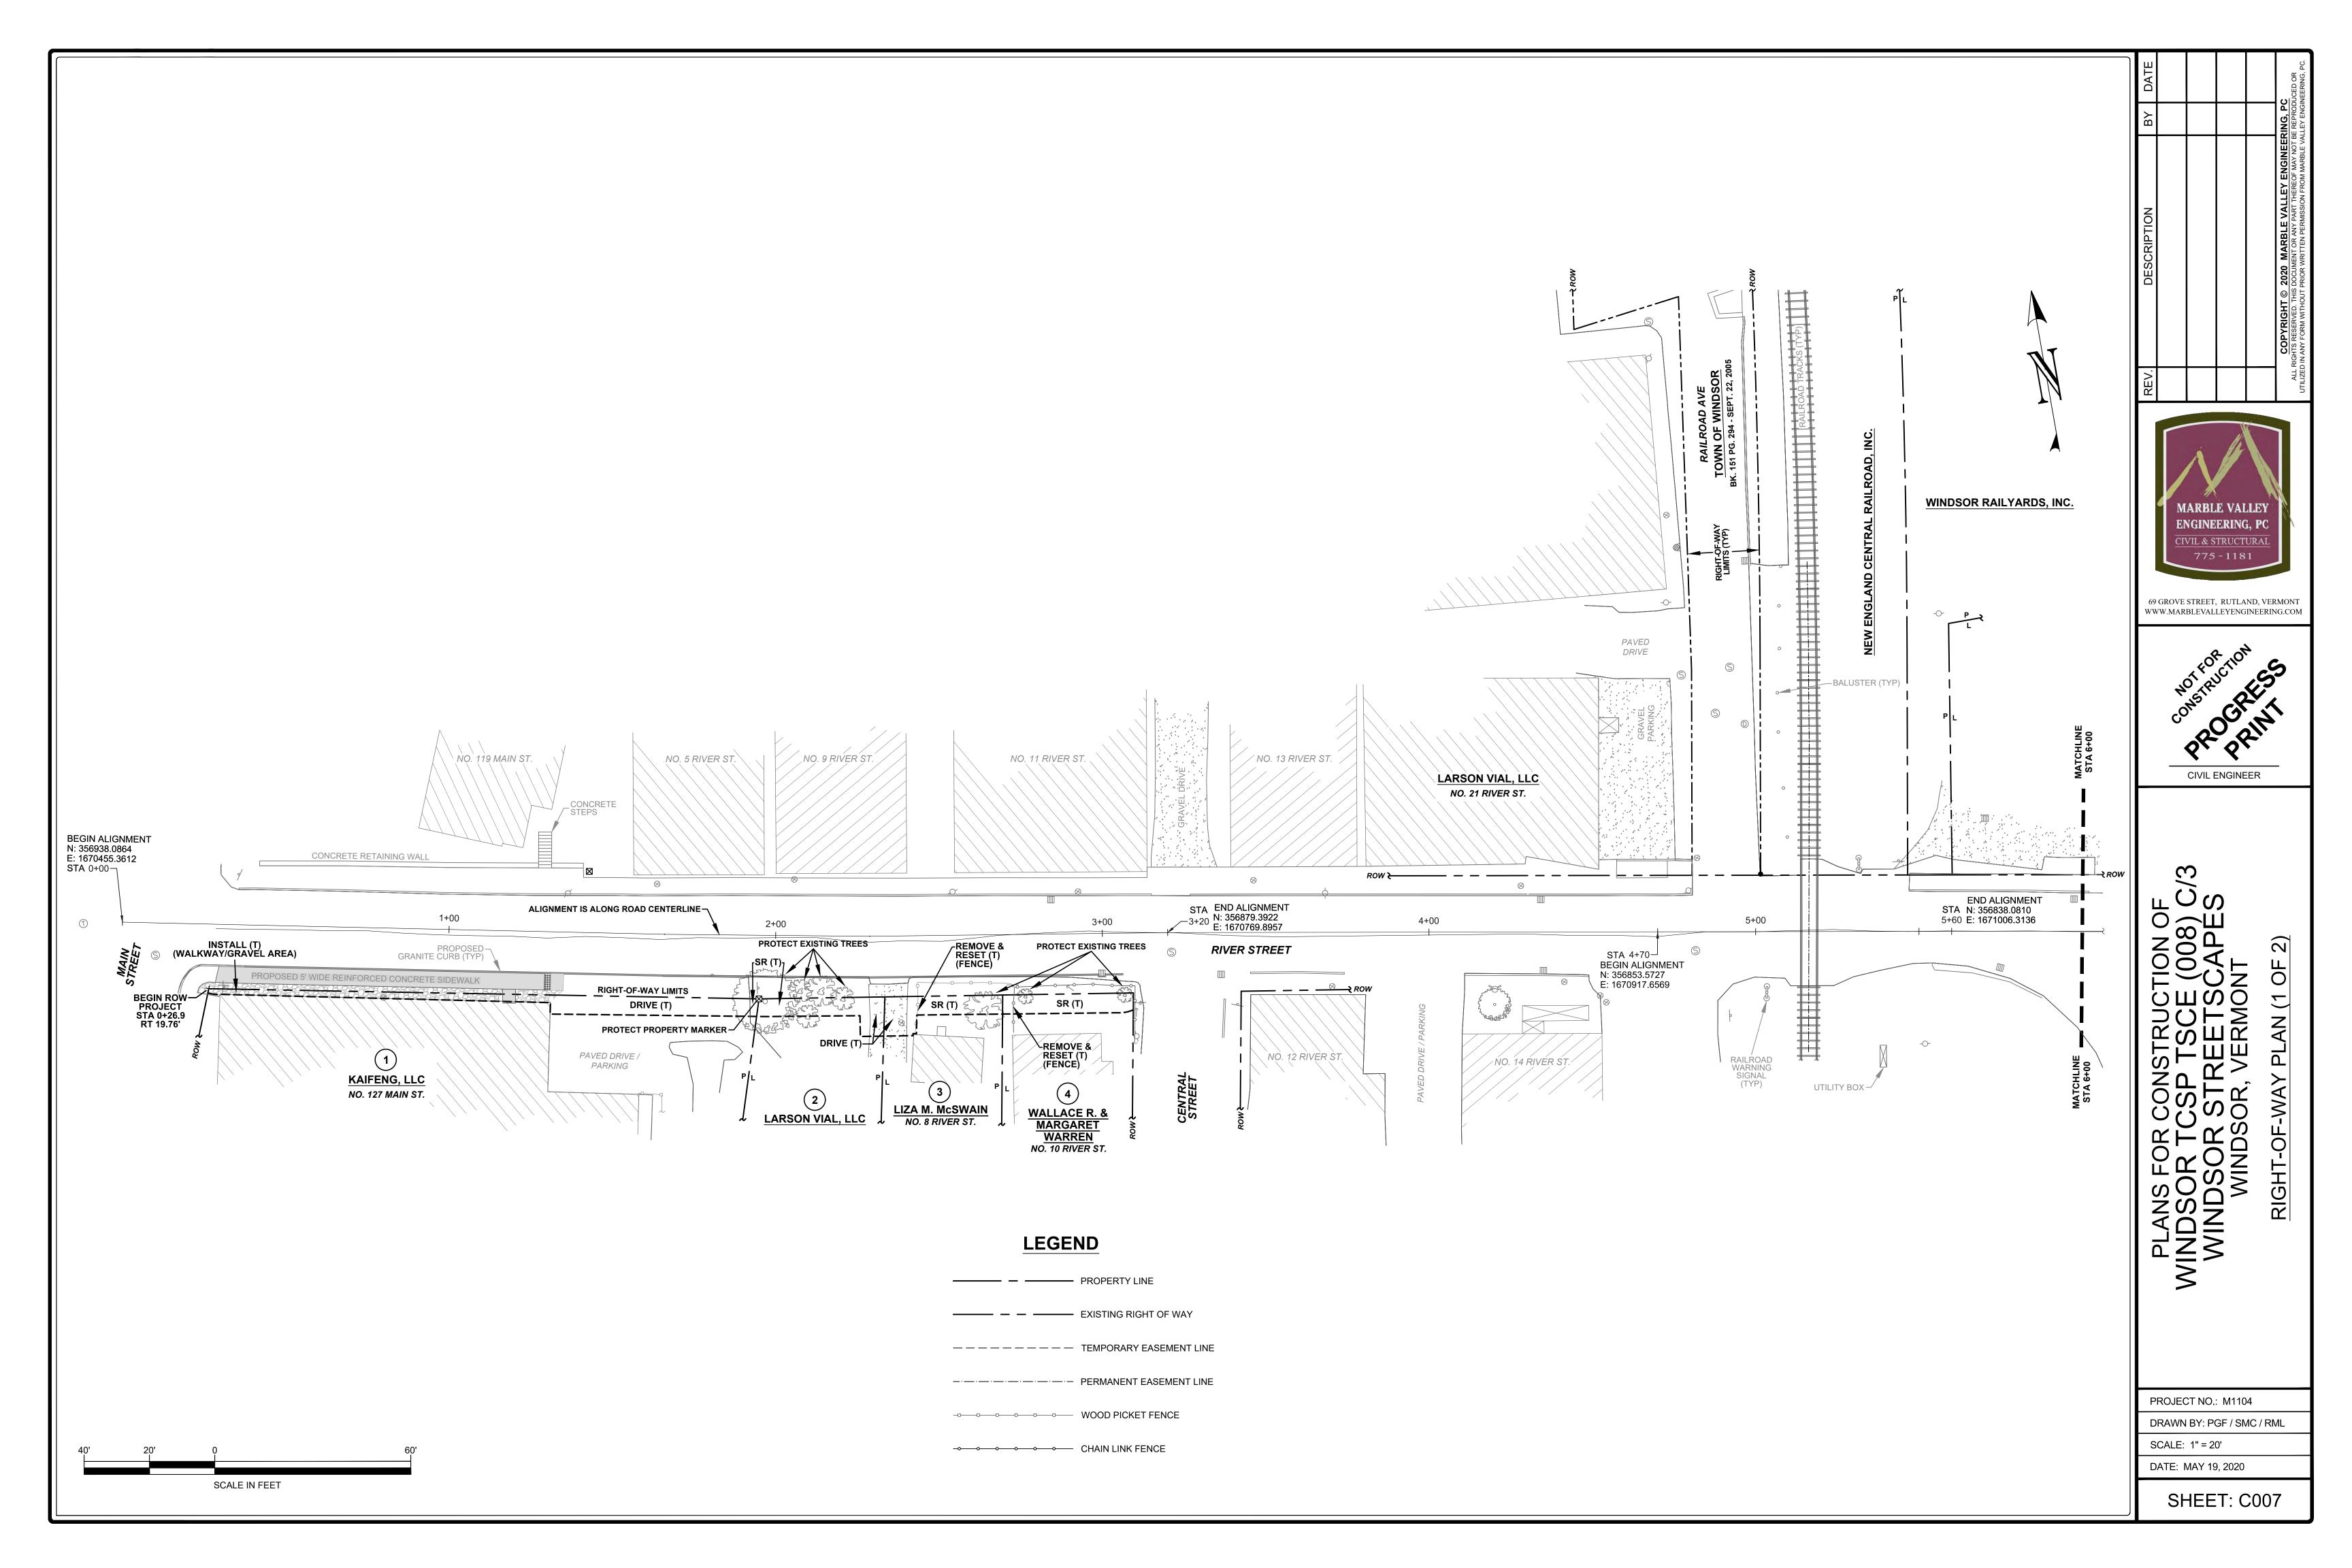


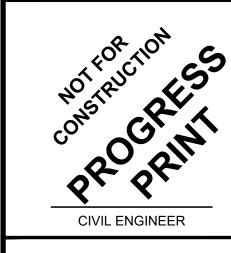
TION OF (008) C (CAPES) PLANS FOR C WINDSOR TC WINDSOR S

PROJECT NO.: M1104

DRAWN BY: SMC / RML

SCALE: NONE DATE: FEBRUARY 20, 2020



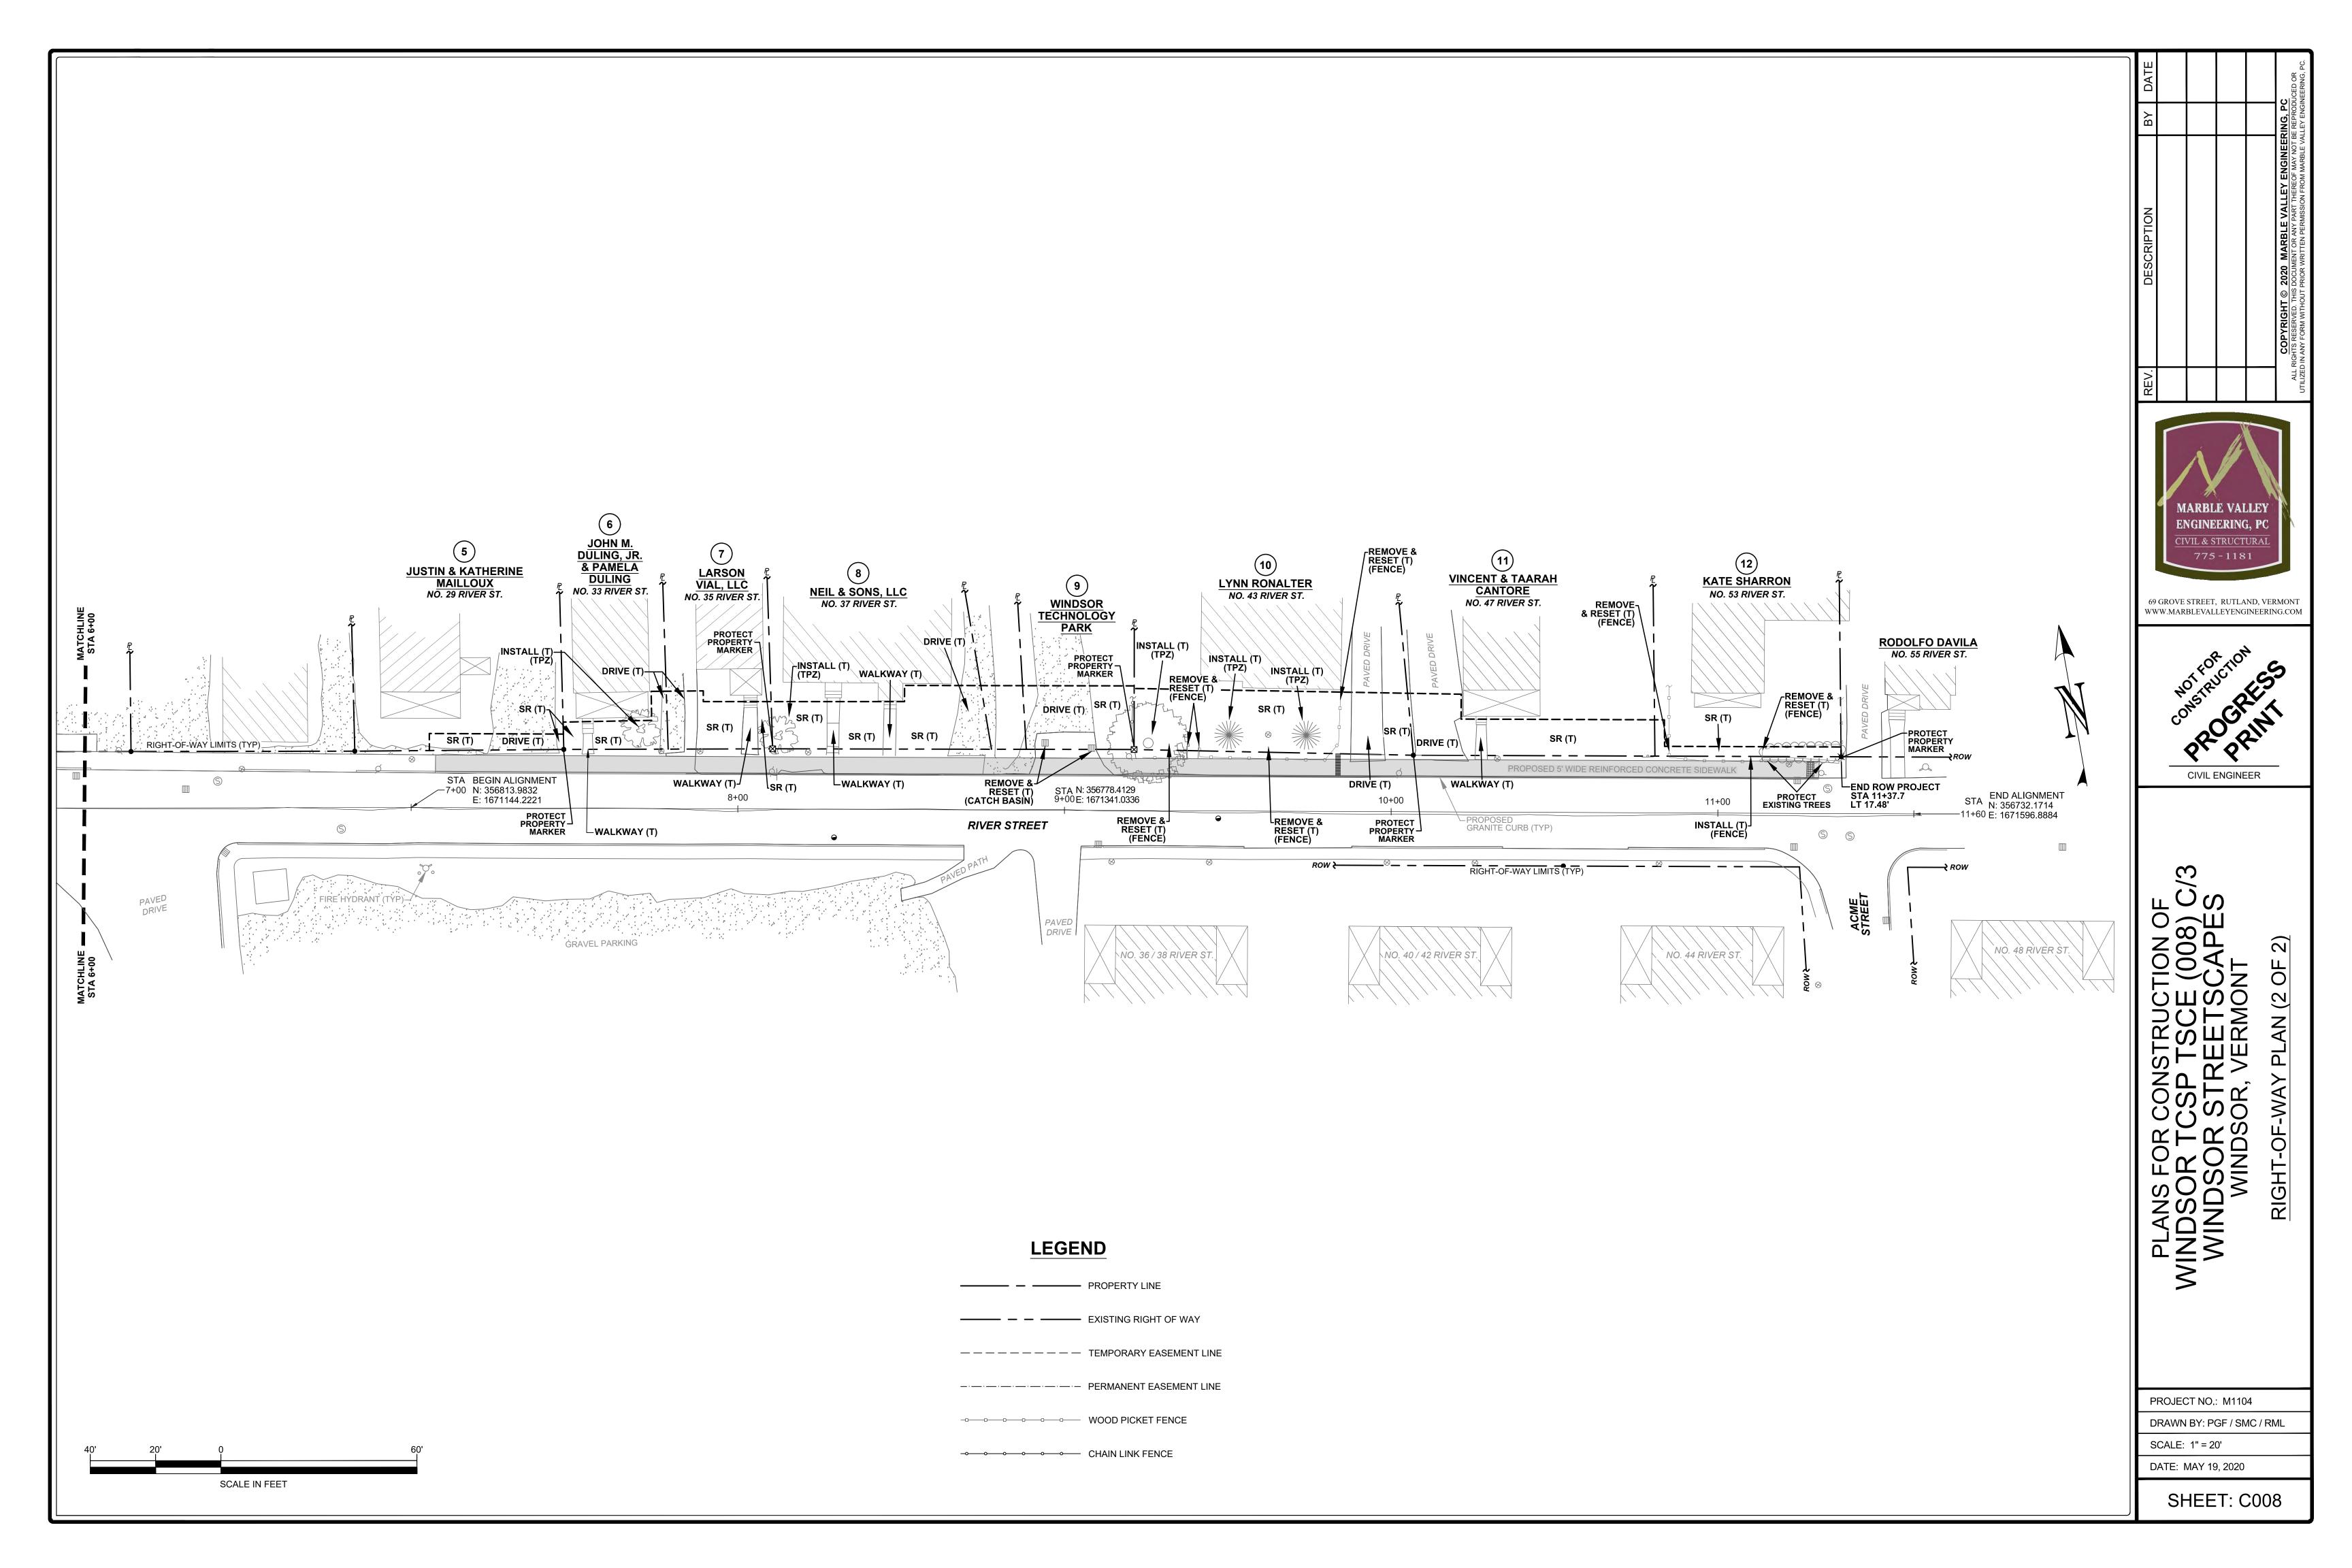

STATE OF VERMONT AGENCY OF TRANSPORTATION

RIGHT - OF - WAY DETAIL SHEET

	TABLE OF PROPERTY ACQUISITION									
PARCEL NC). PROPERTY OWNER	ROW LAYOUT NO.	BEGINNING STATION ENDING	G STATION TAKE REMAINDER AREA± AREA±	RIGHT	T/P AF	RECORDING DATA REA ± TITLE DATE TOWN / CITY BOOK PAGE	REMARKS		
4	KAIEENO II O	0007	0.000 0 DT	04.7.DT IN	OTALL	T 00	20.05	VAVALICIANA VI CODA VIEL A DE A INICILIDEO MINICO OL CODINICIA CINIEEDED		
1	KAIFENG, LLC NO. 127 MAIN ST	C007	1+31.7 RT 1+9	92.3 RT [STALL DRIVE LOPE	T 34	08 SF	WALKWAY / GRAVEL AREA, INCLUDES MINOR SLOPING AS NEEDED INCLUDES MINOR SLOPING AS NEEDED TO BLEND TO EXISTING PAVED DRIVE INCLUDES RIGHT TO PLACE TOP SOIL, SEED AND MULCH		
2	LARSON VIAL, LLC	C007			LOPE		06 SF 5 SF	INCLUDES RIGHT TO INSTALL AND REMOVE PROJECT DEMARCATION FENCE (PDF) AND PLACE TOP SOIL, SEED AND MULCH INCLUDES MINOR SLOPING AS NEEDED TO BLEND TO EXISTING GRAVEL DRIVE		
3	LIZA M. McSWAIN	C007			DRIVE		4 SF	INCLUDES MINOR SLOPING AS NEEDED TO BLEND TO EXISTING GRAVEL DRIVE		
	NO. 8 RIVER ST		2+40.1 RT 2+6 2+43.3 RT		LOPE /E & RESET	T 18	36 SF	INCLUDES RIGHT TO INSTALL AND REMOVE PDF AND PLACE TOP SOIL, SEED AND MULCH WOOD FENCE IS PERPENDICULAR TO ROW, GIVEN CONDITION FENCE MAY NEED TO BE REPLACED		
<u> </u>	WALLACE R. & MARGARET WARREN	C007	2+69.3 RT 3+0	09.3 RT S	LOPE	T 23	36 SF	INCLUDES RIGHT TO INSTALL AND REMOVE PDF AND PLACE TOP SOIL. SEED AND MULCH		
_	NO. 10 RIVER ST	0001	2+72.7 RT		/E & RESET	T	50 51	CHAIN LINK FENCE IS PERPENDICULAR TO ROW, GIVEN CONDITION FENCE MAY NEED TO BE REPLACED		
5	JUSTIN & KATHERINE MAILLOUX	C008	7+04.7 LT 7+2	23.7 LT S	LOPE	T 9	6 SF	INCLUDES RIGHT TO INSTALL AND REMOVE PDF AND PLACE TOP SOIL, SEED AND MULCH		
	NO. 29 RIVER ST				DRIVE LOPE		8 SF 0 0 SF	INCLUDES MINOR SLOPING AS NEEDED TO BLEND TO EXISTING GRAVEL DRIVE INCLUDES RIGHT TO INSTALL AND REMOVE SILT FENCE AND PLACE TOP SOIL, SEED AND MULCH		
			7144.5 21	40.7 E1	LOI L	<u>'</u>		INCOME TO INCINE INCINE NEW OVER SIETT ENGLAND I LAGE TO COIL, CLED AND INCEGT		
6	JOHN M. DULING JR. & PAMELA DULING NO. 33 RIVER ST	C008			LOPE		0 SF 8 SF	INCLUDES RIGHT TO INSTALL AND REMOVE PDF AND PLACE TOP SOIL, SEED AND MULCH INCLUDES MINOR SLOPING AS NEEDED TO BLEND TO EXISTING WALK		
	NO. 00 KIVER OT				LOPE		07 SF	INCLUDES RIGHT TO INSTALL AND REMOVE PDF AND SILT FENCE AND PLACE TOP SOIL, SEED AND MULCH		
			7+70.4 LT 7+76.1 LT 7+7		STALL DRIVE	T	4 SF	TREE PROTECTION ZONE FENCE INCLUDES MINOR SLOPING AS NEEDED TO BLEND TO EXISTING GRAVEL DRIVE		
7	LARSON VIAL, LLC NO. 35 RIVER ST	C008			DRIVE LOPE		62 SF	INCLUDES MINOR SLOPING AS NEEDED TO BLEND TO EXISTING GRAVEL AND PAVED DRIVE INCLUDES RIGHT TO INSTALL AND REMOVE PDF AND PLACE TOP SOIL, SEED AND MULCH		
	NO. 33 RIVER 3 I				LKWAY		6 SF	INCLUDES MINOR SLOPING AS NEEDED TO BLEND TO EXISTING WALK		
			8+06.1 LT 8+ ²	10.6 LT S	LOPE	T 6	3 SF	INCLUDES RIGHT TO INSTALL AND REMOVE PDF AND SILT FENCE AND PLACE TOP SOIL, SEED AND MULCH		
8	NEIL & SONS, LLC	C008	8+10.6 LT 8+2	27.2 LT S	LOPE	T 24	14 SF	INCLUDES RIGHT TO INSTALL AND REMOVE PDF AND PLACE TOP SOIL, SEED AND MULCH		
	NO. 37 RIVER ST		8+12.4 LT		STALL	T		TREE PROTECTION ZONE FENCE		
					LKWAY		5 SF	INCLUDES MINOR SLOPING AS NEEDED TO BLEND TO EXISTING WALK INCLUDES RIGHT TO INSTALL AND REMOVE PDF AND SILT FENCE AND PLACE TOP SOIL, SEED AND MULCH		
					LKWAY		5 SF	INCLUDES MINOR SLOPING AS NEEDED TO BLEND TO EXISTING WALK		
					LOPE		45 SF	INCLUDES RIGHT TO INSTALL AND REMOVE PDF AND SILT FENCE AND PLACE TOP SOIL, SEED AND MULCH		
			8+64.7 LT 8+7	77.6 LT [DRIVE	T 18	30 SF	INCLUDES MINOR SLOPING AS NEEDED TO BLEND TO EXISTING GRAVEL DRIVE		
9	WINDSOR TECHNOLOGY PARK	C008			DRIVE	T 40	09 SF	INCLUDES MINOR SLOPING AS NEEDED TO BLEND TO EXISTING GRAVEL AND PAVED DRIVE		
			8+94.1 LT 9+08.3 LT		/E & RESET /E & RESET	T		CATCH BASIN FRAME AND GRATE CATCH BASIN FRAME AND GRATE		
					LOPE	T 24	45 SF	INCLUDES RIGHT TO INSTALL AND REMOVE PDF AND SILT FENCE AND PLACE TOP SOIL, SEED AND MULCH		
10	LYNN RONALTER	C008	9+21.2 LT 9+8	87.5 LT S	LOPE	T 12	48 SF	INCLUDES RIGHT TO INSTALL AND REMOVE PDF AND SILT FENCE AND PLACE TOP SOIL. SEED AND MULCH		
10	NO. 43 RIVER ST	0000			/E & RESET	T 12	-10 GI	RESET WOOD PICKET FENCE ONE FOOT NORTH OF ROW, GIVEN CONDITION FENCE MAY NEED TO BE REPLACED		
			9+25.5 LT	IN	STALL	Т		TREE PROTECTION ZONE FENCE		
			9+37.3 LT	REMOV	/E & RESET	Т		WOOD PICKET FENCE PERPENDICULAR TO ROW; RESET WOOD PICKET FENCE ONE FOOT NORTH OF ROW, GIVEN CONDITION FENCE MAY NEED TO BE REPLACED		
			9+41.2 LT	REMOV	/E & RESET	Т		WOOD PICKET FENCE PERPENDICULAR TO ROW; RESET WOOD PICKET FENCE ONE FOOT NORTH OF ROW, GIVEN CONDITION FENCE MAY NEED TO BE REPLACED		
					/E & RESET	T		RESET WOOD PICKET FENCE ONE FOOT NORTH OF ROW, GIVEN CONDITION FENCE MAY NEED TO BE REPLACED		
			9+50.2 LT 9+73.9 LT		STALL STALL	T T		TREE PROTECTION ZONE FENCE TREE PROTECTION ZONE FENCE		
					/E & RESET	Т		WOOD PICKET FENCE PERPENDICULAR TO ROW; RESET WOOD PICKET FENCE ONE FOOT NORTH OF ROW, GIVEN CONDITION FENCE MAY NEED TO BE REPLACED		
					DRIVE LOPE		35 SF 59 SF	INCLUDES MINOR SLOPING AS NEEDED TO BLEND TO EXISTING PAVED DRIVE INCLUDES RIGHT TO INSTALL AND REMOVE PDF AND PLACE TOP SOIL, SEED AND MULCH		
								INCLUDES MINOR SLOPING AS NEEDED TO BLEND TO EXISTING PAVED DRIVE AND RIGHT TO INSTALL AND		
11	VINCENT & TAARAH CANTORE	C008			DRIVE		99 SF	REMOVE SILT FENCE		
	NO. 47 RIVER ST				LKWAY		3 SF 8 8 8 8 8 8 8 8 8 8 8 8 8 8 8 8 8 8	INCLUDES RIGHT TO INSTALL AND REMOVE PDF AND SILT FENCE AND PLACE TOP SOIL, SEED AND MULCH INCLUDES MINOR SLOPING AS NEEDED TO BLEND TO EXISTING WALK		
					LOPE		72 SF	INCLUDES RIGHT TO INSTALL AND REMOVE PDF AND SILT FENCE AND PLACE TOP SOIL, SEED AND MULCH		
12	KATE SHARRON	C008	10+80.7 LT 11+	+37.7 LT S	LOPE	T 19	95 SF	INCLUDES RIGHT TO INSTALL AND REMOVE PDF AND PLACE TOP SOIL, SEED AND MULCH		
	NO. 53 RIVER ST		10+85.1 LT		/E & RESET	Т		WOOD FENCE PERPENDICULAR TO ROW; RESET WOOD FENCE AT ROW, GIVEN CONDITION FENCE MAY NEED TO BE REPLACED		
			10+85.1 LT 11+	+13.6 LT IN	STALL	Т		RESET WOOD FENCE AT ROW, GIVEN CONDITION FENCE MAY NEED TO BE REPLACED		
			11+13.6 LT	RFMOV	/E & RESET	т		WOOD FENCE PERPENDICULAR TO ROW; RESET WOOD FENCE AT ROW, GIVEN CONDITION FENCE MAY NEED TO BE REPLACED		

TABL	E OF	REVISIOI	NS
REVISION NO.	ROW SET SHEET#	DESCRIPTION	
	1	İ	

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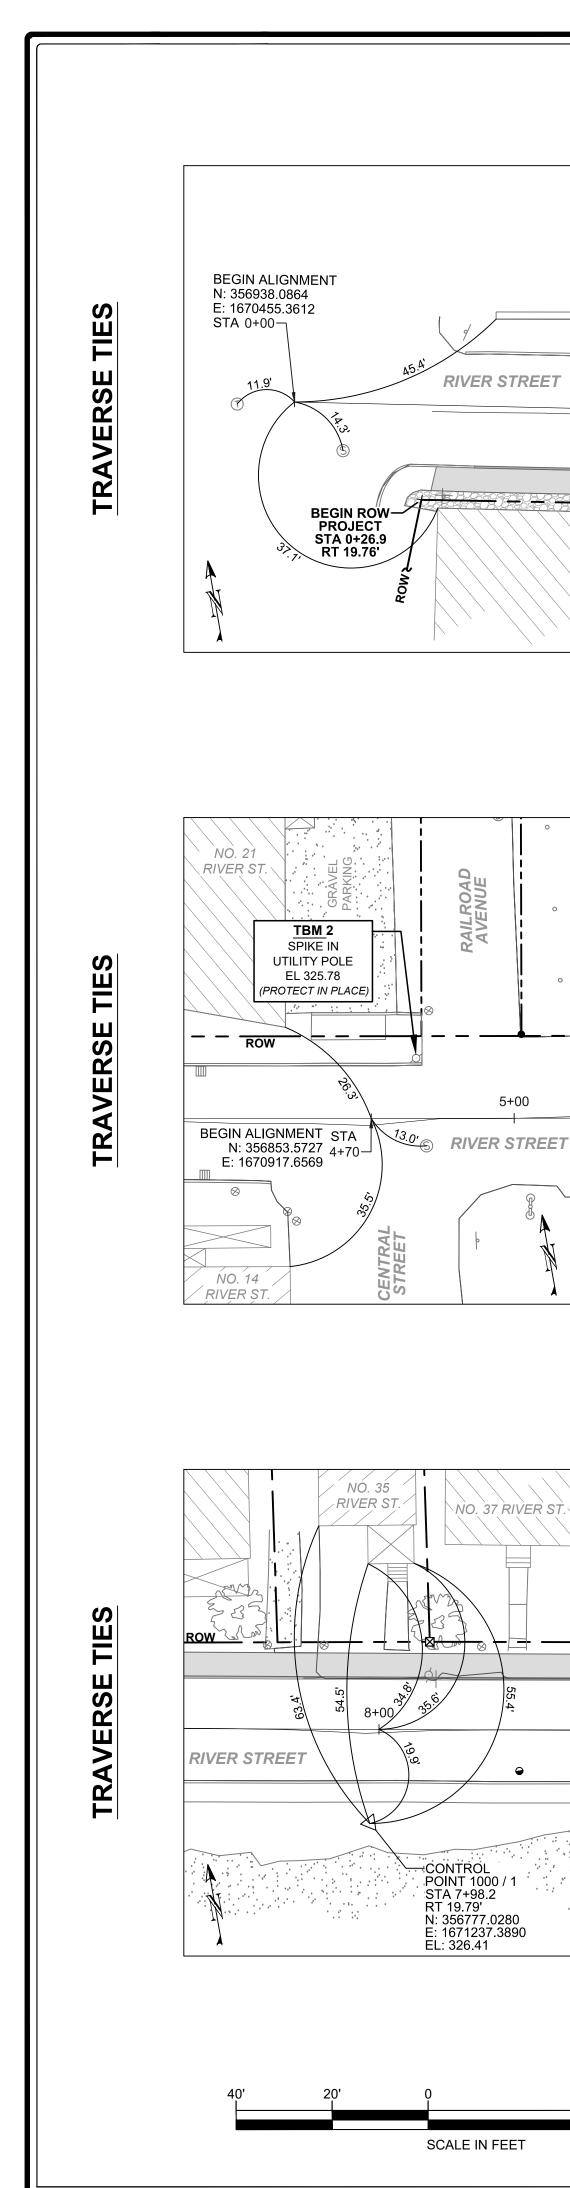
PLANS FOR CONSTRUCTION OF NDSOR TCSP TSCE (008) C/WINDSOR STREETSCAPES WINDSOR, VERMONT


PROJECT NO.: M1104

DRAWN BY: SMC / RML

DATE: MAY 19, 2020

SCALE: NONE



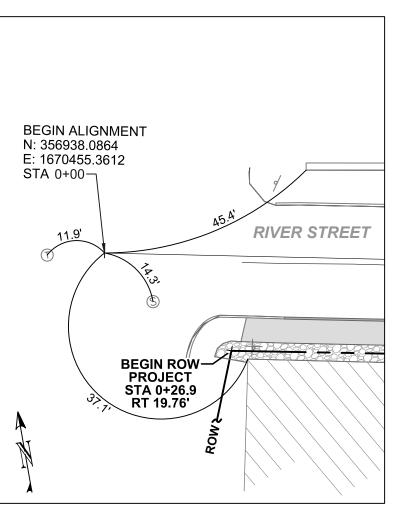


NO. 35 RIVER ST.

NO. 37 RIVER ST

CONTROL
POINT 1000 / 1
STA 7+98.2
RT 19.79'
N: 356777.0280
E: 1671237.3890
EL: 326.41


SCALE IN FEET

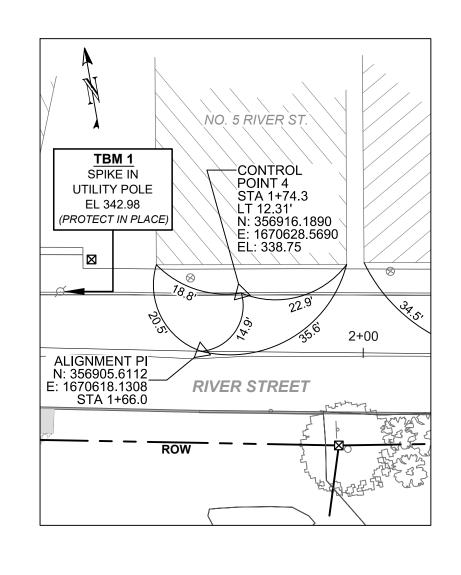

STA N: 356778.4129 9+00 E: 1671341.0336

RIVER STREET

NO. 36 & 38 RIVER ST.

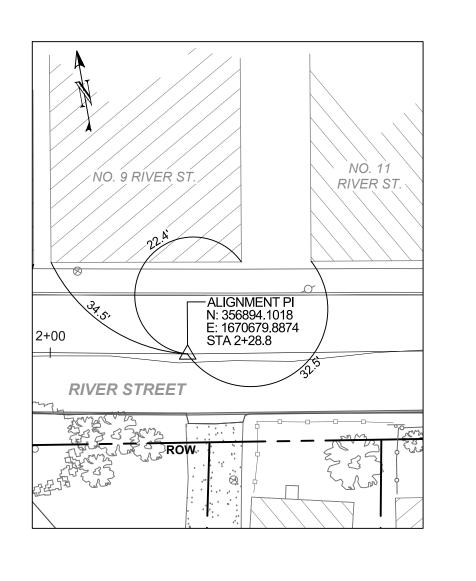

END ALIGNMENT STA N: 356838.0810

5+60 E: 1671006.3136

10+00

NO. 47

RIVER ST


RIVER STREET


NO. 40 & 42 RIVER ST.

RIVER STREET

NO. 43

RIVER ST.

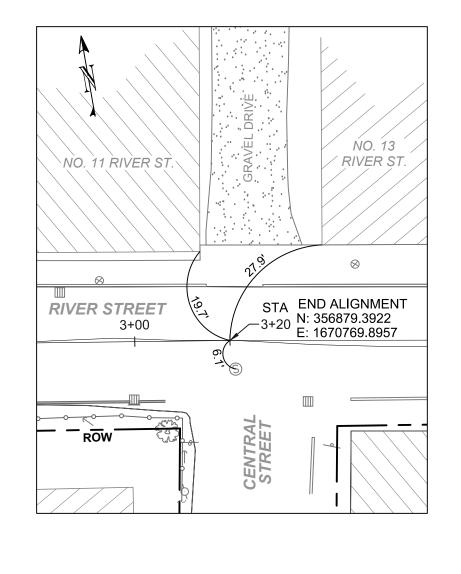


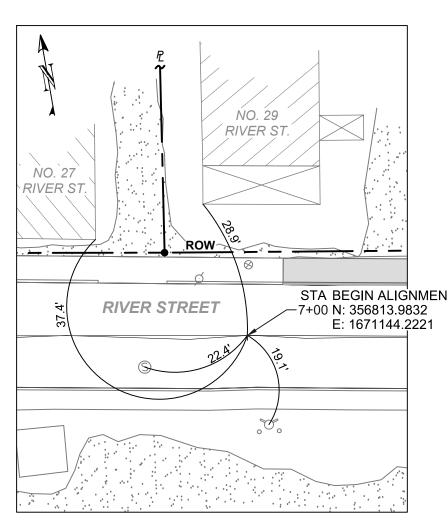



GPS CONTROL POINT


USGS DISC - PID #OD0098 NORTHING = 357212.2724 EASTING = 1670989.4893 ELEVATION = 330.81


LOCATED ON RAILROAD AVENUE AT THE STATION USED BY THE BOSTON AND MAINE RAILROAD AND THE CENTRAL VERMONT RAILWAY, IN THE EAST WALL, 7.8 FEET SOUTH OF THE DOOR LEADING TO THE WAITING ROOM IN THE NORTH END OF THE **BUILDING, AND 3.3 FEET ABOVE** THE CONCRETE PLATFORM. A STANDARD DISK, STAMPED **331.213 Z 5 1927 AND SET VERTICALLY.**

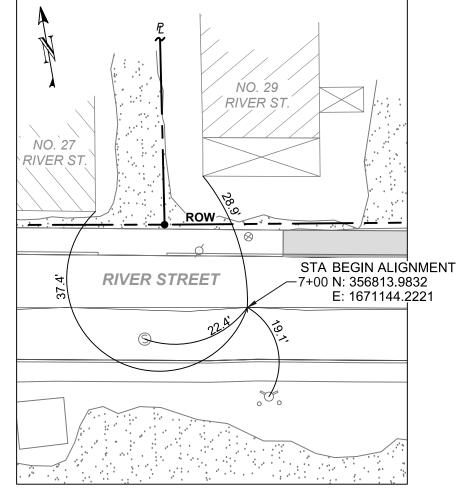


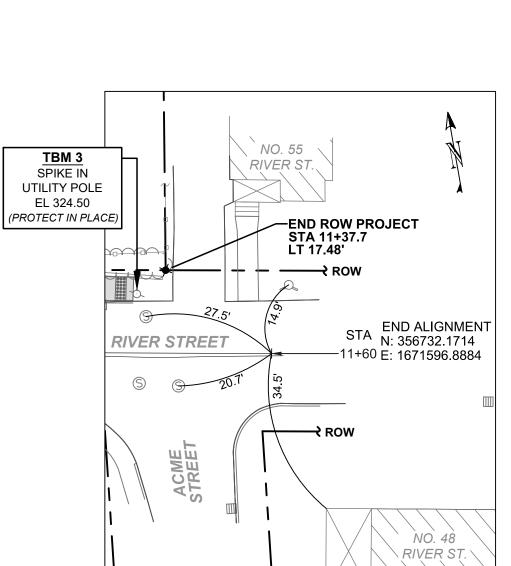

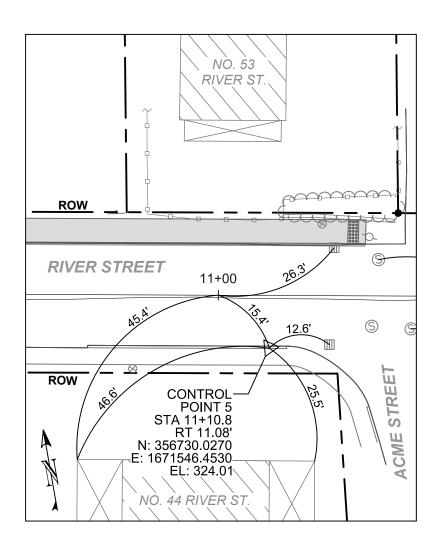

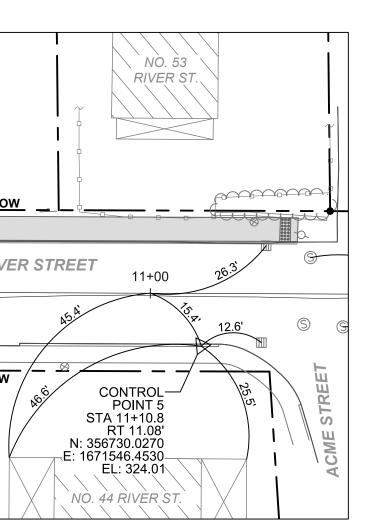

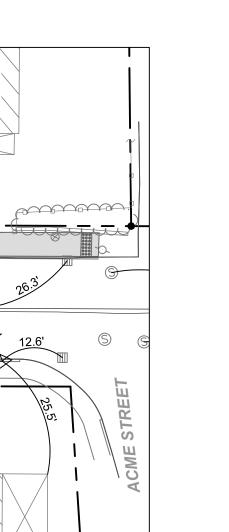

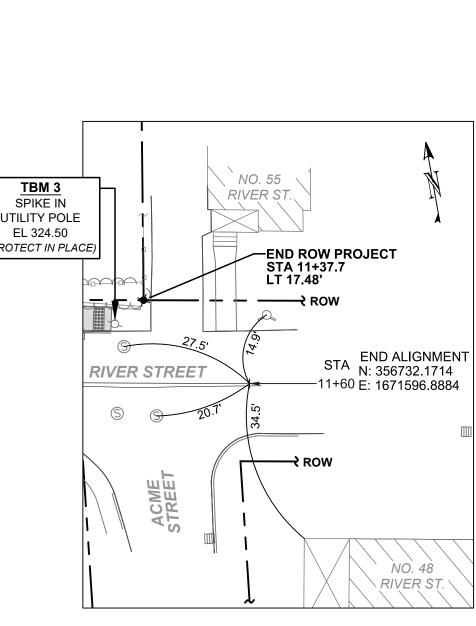




CIVIL ENGINEER

PLANS FOR CONSTRUCTION OF WINDSOR TCSP TSCE (008) C/3 WINDSOR STREETSCAPES WINDSOR, VERMONT

PROJECT NO.: M1104 DRAWN BY: PGF / SMC / RML

SCALE: 1" = 20' DATE: MAY 19, 2020

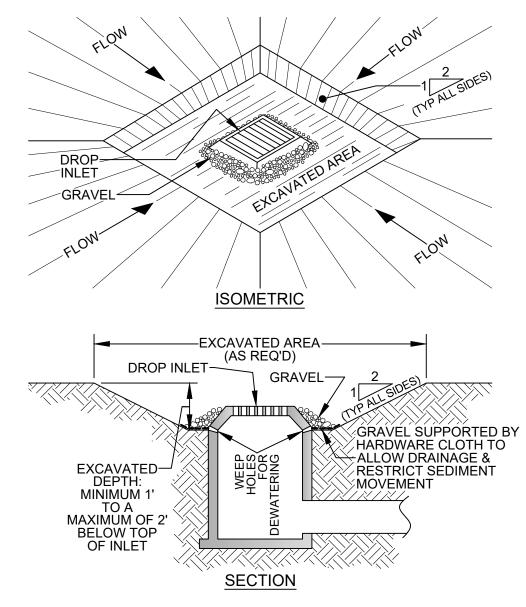

- 1. CLEAR THE AREA OF ALL DEBRIS THAT WILL HINDER EXCAVATION.
- 2. GRADE APPROACH TO THE INLET UNIFORMLY AROUND THE BASIN.
- 3. WEEP HOLES SHALL BE PROTECTED BY GRAVEL.
- 4. UPON STABILIZATION OF CONTRIBUTING DRAINAGE AREA, SEAL WEEP HOLES, FILL EXCAVATION W/ STABLE SOIL TO FINAL GRADE, COMPACT IT PROPERLY & STABILIZE W/ PERMANENT SEEDING.

DETAIL 1 TERMINAL FOLD

DETAIL 2 JUNCTION SLOT

5. MAXIMUM DRAINAGE AREA = 1 ACRE

JUTE MESH EROSION CONROL MATTING

DETAIL 3 ANCHOR SLOT

CONSTRUCTION SPECIFICATIONS:

PER 4' X 150' ROLL OF MATERIAL

GROUND SURFACE. DO NOT STRETCH.

2. APPLY FERTILIZER, LIME SEED PRIOR TO PLACING MATTING.

EXCAVATED DROP INLET SYMBOL PROTECTION DETAIL NOT TO SCALE



EXCELSIOR BLANKET

EROSION CONTROL MATTING

EXCELSIOR BLANKET

. APPLY TO SLOPES GREATER THAN 3H:1V OR WHERE NECESSARY TO AID IN ESTABLISHING VEGETATION.

5. ALL TERMINAL ENDS AND TRANSVERSE LAPS SHALL BE STAPLED AT APPROXIMATELY 12" INTERVALS.

ROLLED EROSION CONTROL PRODUCT OR TURF REINFORCEMENT MAT SIDE SLOPE / TRANSVERSE INSTALLATION DETAIL NOT TO SCALE

3. STAPLES ARE TO BE PLACED ALTERNATELY, IN COLUMNS APPROXIMATELY 2' APART AND IN ROWS APPROXIMATELY 3'


4. DISTURBED AREAS SHALL BE SMOOTHLY GRADED. EROSION CONTROL MATERIAL SHALL BE PLACED LOOSELY OVER

APART. APPROXIMATELY 175 STAPLES ARE REQUIRED PER 4' X 225' ROLL OF MATERIAL AND 125 STAPLES ARE REQUIRED

6"-12"

JUTE MESH, EROSION CONTROL MATTING EXCELSIOR BLANKET SHALL BE BUTTED


DETAIL 4 LAP JOINT

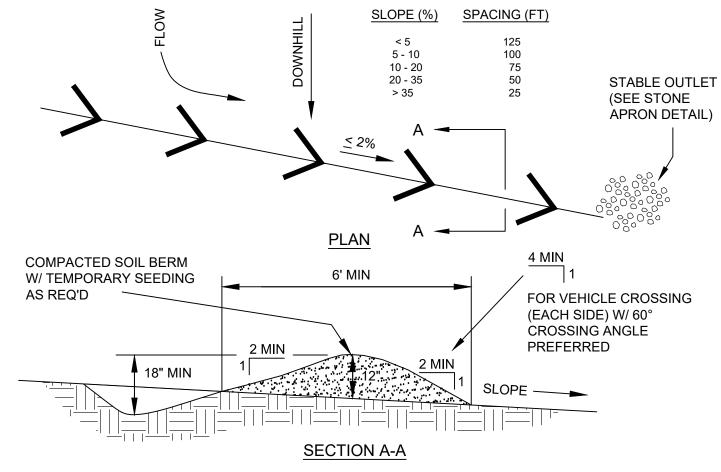


CONSTRUCTION SPECIFICATIONS

- 1. INSTALL THE WATER BAR AS SOON AS THE RIGHT OF WAY IS CLEARED AND GRADED.
- 2. DISK OR STRIP THE SOD FROM THE BASE FOR THE CONSTRUCTED RIDGE BEFORE PLACING FILL.
- 3. TRACK THE RIDGE TO COMPACT IT TO THE DESIGN CROSS SECTION
- 4. THE OUTLET SHALL BE LOCATED ON AN UNDISTURBED AREA. FIELD SPACING WILL BE ADJUSTED TO USE THE MOST STABLE OUTLET AREAS. OUTLET PROTECTION WILL BE PROVIDED WHEN NATURAL AREAS ARE NOT ADEQUATE.
- 5. VEHICLE CROSSING SHALL BE STABILIZED WITH GRAVEL **OR RIP RAP AS APPROPRIATE**. EXPOSED AREAS SHALL BE IMMEDIATELY SEEDED AND MULCHED.
- 6. INSPECT WATER BARS FOR EROSION DAMAGE AND SEDIMENT. CHECK OUTLET AREAS AND MAKE REPAIRS AS NEEDED TO RESTORE OPERATION.


WATER BAR DETAIL NOT TO SCALE

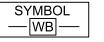


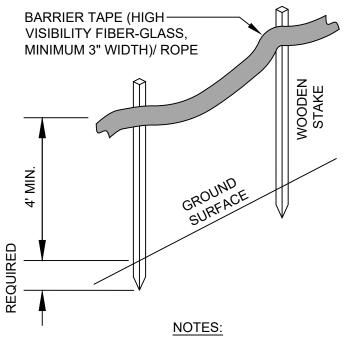

- 1. THIS LIMITS OF DISTURBANCE (LOD) TECHNIQUE TO BE EMPLOYED FOR AREAS MORE THAN 100' FROM A WATER RESOURCE OR AS SHOWN.
- 2. FLAGGING RIBBON MAY BE USED WHERE PROPOSED DISTURBANCE BORDERS ESTABLISHED WOODED AREAS.


CONSTRUCTION FLAGGING BARRIER TAPE/ ROPE DETAIL NOT TO SCALE

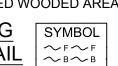

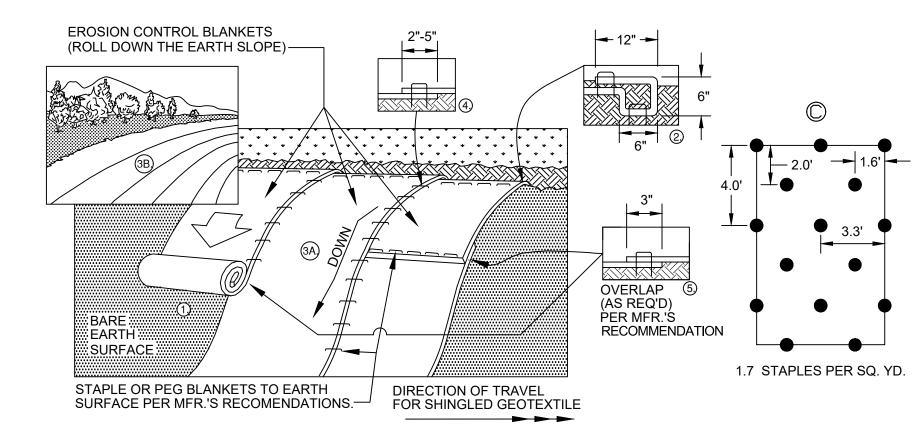

- 1. PREPARE SOIL BEFORE INSTALLING BLANKETS, INCLUDING ANY NECESSARY APPLICATION OF LIME, FERTILIZER, AND SEED.
- 2. BEGIN AT THE TOP OF THE SLOPE BY ANCHORING THE BLANKET IN A 6" DEEP X 6" WIDE TRENCH WITH APPROXIMATELY 12" OF BLANKET EXTENDED BEYOND THE UP-SLOPE PORTION OF THE TRENCH. ANCHOR THE BLANKET WITH A ROW OF STAPLES/STAKES APPROXIMATELY 12" APART IN THE BOTTOM OF THE TRENCH. BACKFILL AND COMPACT THE TRENCH AFTER STAPLING. APPLY SEED TO COMPACTED SOIL AND FOLD REMAINING 12" PORTION OF BLANKET BACK OVER SEED AND COMPACTED SOIL. SECURE BLANKET OVER COMPACTED SOIL WITH A ROW OF STAPLES/STAKES SPACED APPROXIMATELY 12" APART ACROSS THE WIDTH OF THE BLANKET.
- 3. ROLL THE BLANKETS (A.) DOWN OR (B.) HORIZONTALLY ACROSS THE SLOPE. BLANKETS WILL UNROLL WITH APPROPRIATE SIDE AGAINST THE SOIL SURFACE. ALL BLANKETS MUST BE SECURELY FASTENED TO SOIL SURFACE BY PLACING STAPLES/STAKES IN APPROPRIATE LOCATIONS AS SHOWN IN THE MANUFACTURER'S STAPLE PATTERN GUIDE. WHEN USING THE DOT SYSTEM™, STAPLES/STAKES SHOULD BE PLACED THROUGH EACH OF THE COLORED DOTS CORRESPONDING TO THE APPROPRIATE STAPLE PATTERN.
- 4. THE EDGES OF PARALLEL BLANKETS MUST BE STAPLED WITH APPROXIMATELY 2" 5" OVERLAP DEPENDING ON BLANKET
- 5. CONSECUTIVE BLANKETS SPLICED DOWN THE SLOPE MUST BE PLACED END OVER END (SHINGLE STYLE) WITH AN APPROXIMATE 3" OVERLAP. STAPLE THROUGH OVERLAPPED AREA, APPROXIMATELY 12" APART ACROSS ENTIRE BLANKET WIDTH.
- 6. IN LOOSE SOIL CONDITIONS, THE USE OF STAPLE OR STAKE LENGTHS GREATER THAN 6" MAY BE NECESSARY TO PROPERLY SECURE THE BLANKETS.
- 7. APPLICABLE FOR BOTH TEMPORARY & PERMANENT STABILIZATION CONDITIONS


ROLLED EROSION CONTROL PRODUCT OR TURF REINFORCEMENT MAT SIDE SLOPE / TRANSVERSE INSTALLATION DETAIL NOT TO SCALE

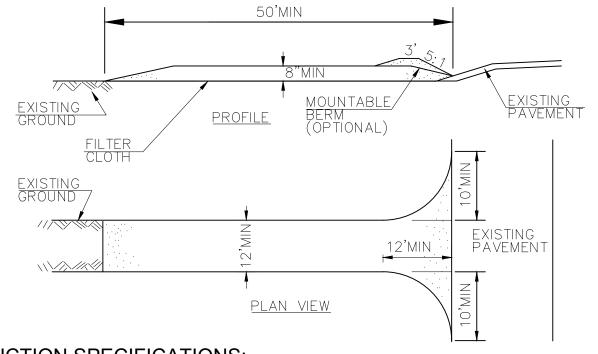

CONSTRUCTION SPECIFICATIONS:

- 1. STONE SIZE USE 1-4" STONE, RECLAIMED OR RECYCLED CONCRETE EQUIVALENT.
- 2. LENGTH NOT LESS THAN 50' (EXCEPT ON A SINGLE RESIDENCE LOT WHERE A 30' MINIMUM LENGTH APPLIES). 3. THICKNESS - NOT LESS THAN 8".
- 4. WIDTH 12' MINIMUM, BUT NOT LESS THAN THE FULL WIDTH AT POINTS WHERE INGRESS OR EGRESS OCCURS. 24' IF
- SINGLE ENTRANCE TO SITE. 5. GEOTEXTILE MUST BE PLACED OVER THE ENTIRE AREA PRIOR TO PLACING STONE.
- 6. SURFACE WATER ALL SURFACE WATER FLOWING OR DIVERTED TOWARD CONSTRUCTION ENTRANCES SHALL BE PIPED BENEATH THE ENTRANCE. IF PIPING IS IMPRACTICAL, A MOUNTABLE BERM WITH 5:1 SLOPES WILL BE PERMITTED.
- 7. MAINTENANCE THE ENTRANCE SHALL BE MAINTAINED IN A CONDITION WHICH WILL PREVENT TRACKING OR FLOWING OF SEDIMENT ONTO PUBLIC RIGHTS-OF-WAY, ALL SEDIMENT SPILLED, DROPPED, WASHED OR TRACKED ONTO PUBLIC RIGHTS-OF-WAY MUST BE REMOVED IMMEDIATELY.
- 8. WHEN WASHING IS REQUIRED, IT SHALL BE DONE ON AN AREA STABILIZED WITH STONE AND WHICH DRAINS INTO AN APPROVED SEDIMENT TRAPPING DEVICE.
- 9. PERIODIC INSPECTION AND NEEDED MAINTENANCE SHALL BE PROVIDED ACCORDING TO PERMIT REQUIREMENTS.




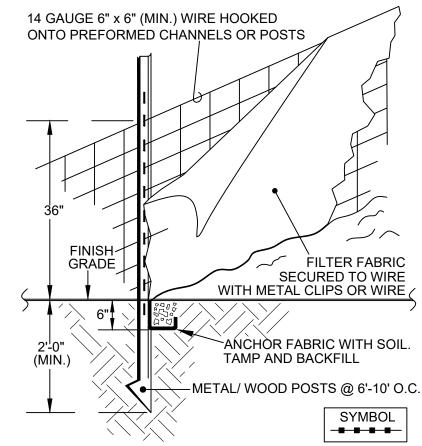

SYMBOL


SILT FENCE DETAIL NOT TO SCALE

STABILIZED CONSTRUCTION ENTRANCE NOT TO SCALE

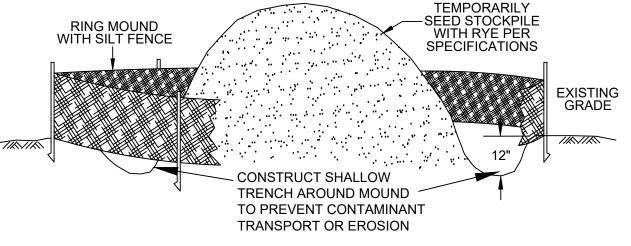

TEMPORARILY SEED STOCKPILE WITH RYE PER SPECIFICATIONS

TOPSOIL STOCKPILE SECTION DETAIL NOT TO SCALE

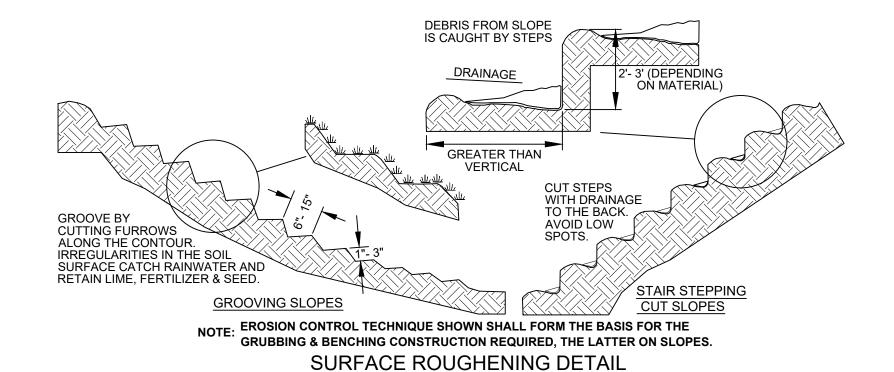


NOT TO SCALE

(SNOW FENCE) OR ORANGE WEBBING (CONSTRUCTION FENCE) THIS LIMITS OF DISTURBANCE (LOD) TECHNIQUE TO BE **EMPLOYED FOR AREAS WITHIN** 100' OF A WATER RESOURCE OR AS SHOWN

CONSTRUCTION / SNOW FENCE DETAIL

NOT TO SCALE

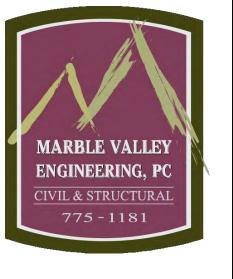

69 GROVE STREET, RUTLAND, VERMONT WWW.MARBLEVALLEYENGINEERING.COM



88 P

PROJECT NO.: M1104

DRAWN BY: PGF/SMC/RML

DATE: FEBRUARY 20, 2020

SCALE: NONE

Windsor Streetscapes Project, TCSP TCSE(008) C/3 85% Construction Cost Estimate

Item Number	Item Description	Units	2 year pricing*	5 year pricing*	Pricing Used	Quantity	Cost
203.15	Common Excavation	CY	\$15.14	\$14.30	\$15.14	460.00	\$6,964.40
203.17	Unclassified Excavation (contingency)	CY	\$11.63	\$17.20	\$17.20	1.00	\$17.20
203.28	Excavation of Surfaces and Pavements	СҮ	\$31.20	\$32.11	\$32.11	96.00	\$3,082.56
203.31	Sand Borrow (contingency)	CY	\$30.95	\$29.64	\$30.95	10.00	\$309.50
210.10	Cold Planing, Bituminous Pavement	SY	\$2.51	\$2.64	\$2.64	410.00	\$1,082.40
301.15	Subbase of Gravel	CY	\$39.46	\$42.47	\$42.47	110.00	\$4,671.70
301.26	Subbase of Crushed Gravel, Fine Graded	CY	\$43.36	\$44.41	\$44.41	160.00	\$7,105.60
401.10	Aggregate Surface Course	CY	\$55.91	\$55.20	\$55.91	20.00	\$1,118.20
406.25	Marshall Bituminous Concrete Pavement	TON	\$234.31	\$209.15	\$234.31	80.00	\$18,744.80
541.25	Concrete, Class B (contingency)	CY	\$1,442.69	\$1,136.53	\$1,442.69	5.00	\$7,213.45
604.40	Changing Elevation of Drop Inlets, Catchbasins or Manholes	EA	\$898.50	\$928.29	\$928.29	3.00	\$2,784.87
604.46	Cast Iron Grate with Frame, Type B (modified with curb inlet)	EA		\$1,001.35	\$1,001.35	1.00	\$1,001.35
613.10	Stone Fill, Type I	СҮ	\$65.56	\$60.54	\$65.56	10.00	\$655.60
616.21	Vertical Granite Curb	LF	\$56.65	\$57.92	\$57.92	550.00	\$31,856.00
616.41	Removal of Existing Curb	LF	\$7.29	\$9.45	\$9.45	234.00	\$2,211.30
616.47	Bituminous Concrete Gutters and Traffic Islands	TON	\$253.69	\$260.65	\$260.65	65.00	\$16,942.25
617.10	Relocate Mailbox, Single Support (contingency)	EA	\$175.60	\$195.72	\$195.72	1.00	\$195.72
618.10	Portland Cement Concrete Sidewalk, 5 inch	SY	\$122.51	\$102.43	\$122.51	275.00	\$33,690.25
618.11	Portland Cement Concrete Sidewalk, 8 inch	SY	\$175.98	\$131.45	\$175.98	25.00	\$4,399.50
618.30	Detectable Warning Surface	SF	\$44.05	\$52.21	\$52.21	30.00	\$1,566.30
620.50	Removing and Resetting Fence	LF	\$13.54	\$15.98	\$15.98	120.00	\$1,917.60

Windsor Streetscapes Project, TCSP TCSE(008) C/3 85% Construction Cost Estimate

Item Number	Item Description	Units	2 year pricing*	5 year pricing*	Pricing Used	Quantity	Cost
630.15	Flaggers	HR	\$43.38	\$35.75	\$43.38	200.00	\$8,676.00
635.11	Mob / Demob	LS			\$17,489.25	1.00	\$17,489.25
641.10	Traffic Control	LS			\$12,676.09	1.00	\$12,676.09
649.11	Geotextile for Roadbed Separator	SY	\$1.28	\$1.44	\$1.44	20.00	\$28.80
649.31	Geotextile under Stone Fill	SY	\$3.66	\$3.81	\$3.81	40.00	\$152.40
651.15	Seed	LB	\$11.90	\$10.11	\$11.90	10.00	\$119.00
651.18	Fertilizer	LB	\$5.34	\$4.43	\$5.34	100.00	\$534.00
651.35	Topsoil	CY	\$52.36	\$33.68	\$52.36	100.00	\$5,236.00
653.10	Hay Mulch	TON	\$992.49	\$992.49	\$992.49	0.50	\$496.25
653.20	Rolled Erosion Control Product Type I	SY	\$2.16	\$1.92	\$2.16	370.00	\$799.20
653.35	Stabilized Construction Entrance	СҮ	\$64.71	\$60.80	\$64.71	15.00	\$970.65
653.41	Inlet Protection Device, Type II	EA	\$285.59	\$215.41	\$285.59	3.00	\$856.77
653.476	Silt Fence Type II	LF	\$6.48	\$6.48	\$6.48	130.00	\$842.40
653.50	Barrier Fence	LF	\$2.92	\$1.86	\$2.92	1,130.00	\$3,299.60
653.60	Erosion Log (contingency)	LF	\$3.96	\$3.24	\$3.96	20.00	\$79.20
656.50	Transplanting Shrubs (contingency)	EA	\$300.98	\$235.66	\$300.98	1.00	\$300.98
656.85	Tree Protection	LS	\$4,915.21	\$4,536.11	\$4,915.21	1.00	\$4,915.21
675.50	Removing Signs (contingency)	EA	\$13.85	\$14.22	\$14.22	1.00	\$14.22
675.60	Resetting Signs (contingency)	EA	\$32.84	\$31.42	\$32.84	1.00	\$32.84
900.540	Trench Drain	LF			\$109.05	10.00	\$1,090.50
900.541	6 foot Fence, various materials (contingency)	LF			\$34.73	20.00	\$694.60
		SubTo	otal				\$206,834.51
	Total	without	Contingency				\$206,834.51

Attachment G: 2023 Additional Funding Worksheet

Applicant Name: Town of Windsor

Project Title: River Street Sidewalk Improvements

Determining Make Up Funding for an Existing Project

Original Award (including Local	
share)	\$193,630
Engineering Expenses to Date	\$17,113
Project Management Expenses	
to Date	\$12,983
ROW expenses to Date	

Amount Remaining from original award \$163,534

Balance of Engineering contract	
to be billed	\$20,387
Balance of Project	
Management to end of project	\$7,017
Balance of ROW expenses	
anticipated	\$3,000
Estimated Construction Cost	\$225,000
Estimated Construction	
Inspection Cost	\$33,750

Total Cost to Complete Project \$289,154

Amount Remaining in (\$125,620)
Grant Award (or deficit)



June 8, 2023

Peter Pochop, Project Manager Project Delivery Bureau, Municipal Assistance, VTrans 219 North Main Street Barre VT 05641

SUBJECT: Statement of Support for Windsor's Bicycle and Pedestrian Grant Application

Dear Mr. Pochop:

The Town of Windsor is applying to the 2023 Bicycle and Pedestrian Program for additional funding to complete their River Street Sidewalk Improvement Project [Windsor TCSP TCSE(008)]. These improvements make important pedestrian improvements that connect a low-income neighborhood to the Downtown.

Inflation has made it very difficult to complete this project as presently scoped. Additional funds are necessary to successfully complete this project.

Staff at Mount Ascutney Regional Commission (MARC) have not only reviewed this application, but helped to prepare it. MARC staff are assisting the town with project management activities.

This project is consistent with and furthers goals of both the Regional Plan and Town Plan. Specifically, this project would address a key pedestrian need in the Regional Transportation Plan by: "[m]ak[ing] logical sidewalk and multi-use path network expansions to make connections between destinations."

This is an important project, and one that MARC staff has been working on for many years with town officials. Thank you for your consideration.

Sincerely,

Jason Rasmussen, AICP

ason Rasmussen

Executive Director



Town of Windsor, Vermont 29 Union St. Windsor, VT 05089 (802) 674-6786

May 23, 2023

Peter Pochop, Bicycle and Pedestrian Project Manager

VTrans Project Delivery Bureau - Municipal Assistance

219 North Main Street

Barre VT 05641

SUBJECT: Selectboard Letter of Support – Additional Funds for River Street Sidewalk

Improvements in Windsor

Dear Mr. Pochop:

The Town of Windsor is in full support of the Bicycle and Pedestrian Program application for additional funds for the ongoing River Street Sidewalk Improvement Project [Windsor TCSP TSCE (008)].

This project seeks to make important improvements to the existing sidewalk along River Street. These improvements will make safer non-motorized access to downtown Windsor for residents in this low- income neighborhood along the Connecticut River. These improvements will contribute toward the Town's goals to revitalize this neighborhood.

Inflation has increased the anticipated project costs. The total cost of the project is now estimated to be \$319,250 based on estimates from Marble Valley Engineering. We are applying for additional funds to supplement past awards through a federal earmark. The additional costs are \$101,644 for construction, \$6,227 for engineering, \$8,750 for construction inspection, and \$9,000 for municipal project management. We believe the current levels of funding for right-of-way are sufficient. The Town is requesting a new Bicycle and Pedestrian award of \$100,497, which combined with the original award equals a total of \$257,492 in federal funding. The Town is committed to providing local match funds for this 2023 request of \$25,124 which, combined with the original match of \$36,635, is a total of \$61,759 in local cash match.

The Town is committed to the future maintenance responsibility for these sidewalk improvements.

Thank you for your consideration.

Sincerely,

Jeffrey Johnson, Chair Windsor Selectboard